
PROPOSED SUBDIVISION **LEPPINGTON - STAGE 1**

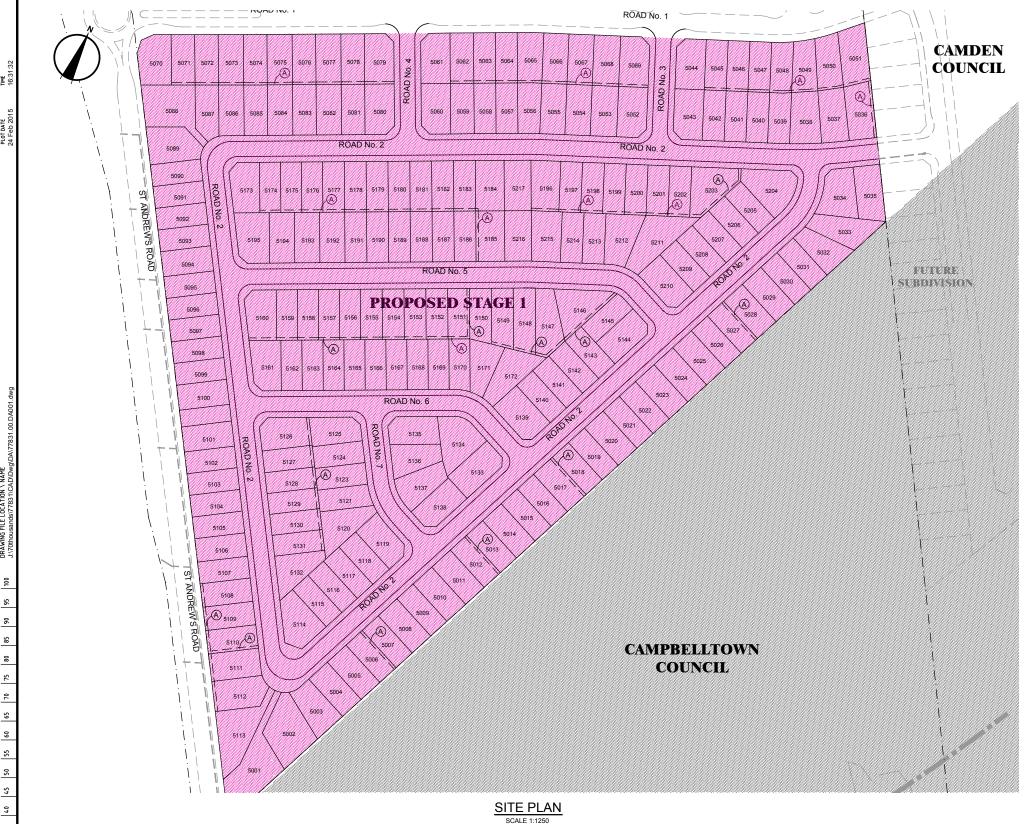



LOCALITY PLAN

SCALE: NTS

SURV	SURVEY CONTROL:							
POINT No.	EASTING NORTHING		REDUCED LEVEL	REMARKS				
1	290122.371	6228043.755	85.590	SSM 171456				
2	290702.832	6228291.449	92.450	SSM 160359				
3	290548.151	6228040.096	88.199	SSM 168937				
6	291666.463	6227325.838	111.094	SSM103826				
7	291078.630	6228621.485	111.053	SSM159634				
8	292282.682	6227703.434	140.7030	PM53547				
NOTE: C	NOTE: CO-ORDINATES ARE MGA (GROUND)							

LEGEND:

STAGE 1

CAMPBELLTOWN CITY COUNCIL AREA

 \circ

SURVEY CONTROL MARK

EASEMENT INFORMATION:

EASEMENT FOR DRAINAGE 1.5m WIDE

24/02/15 LR/PX N/A PP Principal LAYOUT REVISED, STAGES COMBINED. B ADD RETAINING WALL HEIGHTS 10/10/14 MS - JH INITIAL ISSUE TO COUNCIL FOR DEVELOPMENT APPLICATION 26/09/14 LR/MS - PP DATE DES/DET WVR APP'D



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P. PARFENOW Designed J. HYNES Drawn M. NEILSON Checked P. PARFENOW Authorised P. G. McNAMARA

Date SEPTEMBER 2014

Scale @ A1

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LEPPINGTON

STAGE 1 CAMDEN COUNCIL COVER SHEET - SITE PLAN & LOCALITY PLAN

Drawing No. 77831.00.DA001

SHEET SCHEDULE:

REV	SHEET	DRAWING	DESCRIPTION	
С	1	77831.00.DA001	COVER SHEET - SITE PLAN & LOCALITY PLAN	
D	2	77831.00.DA002	SHEET SCHEDULE & NOTES	
D	3	77831.00.DA101	SITE REGRADING PLAN SHEET 1 OF 6	
D	4	77831.00.DA102	SITE REGRADING PLAN SHEET 2 OF 6	
D	5	77831.00.DA103	SITE REGRADING PLAN SHEET 3 OF 6	
D	6	77831.00.DA104	SITE REGRADING PLAN SHEET 4 OF 6	
D	7	77831.00.DA105	SITE REGRADING PLAN SHEET 5 OF 6	
D	8	77831.00.DA106	SITE REGRADING PLAN SHEET 6 OF 6	
С	9	77831.00.DA201	TYPICAL CROSS SECTIONS 16m WIDE LOCAL ROAD	
D	10	77831.00.DA202	TYPICAL CROSS SECTIONS 20m WIDE COLLECTOR ROAD	
С	11	77831.00.DA211	LONGITUDINAL SECTIONS ROAD No. 1	
С	12	77831.00.DA212	LONGITUDINAL SECTIONS ROAD No. 2 - SHEET 1 OF 2	
С	13	77831.00.DA213	LONGITUDINAL SECTIONS ROAD No. 2 - SHEET 2 OF 2	
С	14	77831.00.DA214	LONGITUDINAL SECTIONS ROAD No. 3, ROAD No. 4 & ROAD No. 5	
С	15	77831.00.DA215	LONGITUDINAL SECTIONS ROAD No. 6 & ROAD No. 7	
С	16	77831.00.DA216	LONGITUDINAL SECTIONS ST ANDREW'S ROAD	
С	17	77831.00.DA501	CUT & FILL PLAN	
С	18	77831.00.DA601	CONCEPT DRAINAGE PLAN SHEET 1 OF 6	
С	19	77831.00.DA602	CONCEPT DRAINAGE PLAN SHEET 2 OF 6	
С	20	77831.00.DA603	CONCEPT DRAINAGE PLAN SHEET 3 OF 6	
С	21	77831.00.DA604	CONCEPT DRAINAGE PLAN SHEET 4 OF 6	
С	22	77831.00.DA605	CONCEPT DRAINAGE PLAN SHEET 5 OF 6	
С	23	77831.00.DA606	CONCEPT DRAINAGE PLAN SHEET 6 OF 6	
С	24	77831.00.DA611	CONCEPT CATCHMENT PLAN	
D	25	77831.00.DA701	SOIL & WATER MANAGEMENT PLAN	
С	26	77831.00.DA711	SOIL & WATER MANAGEMENT DETAILS & NOTES	
С	27	77831.00.DA811	LINE MARKING & SIGN POSTING PLAN SHEET 1 OF 2	
С	28	77831.00.DA812	LINE MARKING & SIGN POSTING PLAN SHEET 2 OF 2	
С	29	77831.00.DA901	DEMOLITION PLAN	

GENERAL NOTES:

- 1. ALL WORK TO BE CARRIED OUT IN ACCORDANCE WITH CAMDEN COUNCIL'S SPECIFICATIONS AND TO THE REQUIREMENTS OF COUNCIL'S ENGINEER.
- 2. INSPECTIONS BY THE CAMDEN COUNCIL'S ENGINEER SHALL BE CARRIED OUT AT THE FOLLOWING STAGES: PRIOR TO INSTALLATION OF EROSION AND SEDIMENT CONTROL STRUCTURES
- 2.2. FINAL INSPECTION AFTER ALL WORKS ARE COMPLETED AND 'WORK AS EXECUTED' PLANS HAVE BEEN SUBMITTED TO COUNCIL
- SUBMITTED TO COUNCIL

 NO TREES TO BE REMOVED UNLESS APPROVAL IS GRANTED BY COUNCIL'S LANDSCAPE COMPLIANCE OFFICER.

 4. MAKE SMOOTH JUNCTIONS WITH EXISTING WORKS.

- NO WORK TO BE CARRIED OUT ON COUNCIL PROPERTY OR ADJOINING PROPERTIES WITHOUT THE WRITTEN PERMISSION FROM THE OWNER'S.
- VEHICULAR ACCESS AND ALL SERVICES TO BE MAINTAINED AT ALL TIMES TO ADJOINING PROPERTIES AFFECTED BY CONSTRUCTION
- AFFECTED BY CONSTRUCTION.
 ALL RUBBISH, BUILDINGS, SHEDS AND FENCES TO BE REMOVED TO SATISFACTION OF COUNCIL'S ENGINEER.
 THE CONTRACTOR SHALL OBTAIN ALL LEVELS FROM ESTABLISHED BENCH MARKS ONLY.
 PERMANENT SURVEY CO-ORDINATION MARKS MUST BE PLACED WITHIN THE SUBDIVISION IN ACCORDANCE
- WITH THE SURVEYORS ACT AND REGULATIONS.

 10. PLACE AND LEVEL NEW S.S.M.'S TO DEPARTMENT OF LAND & WATER CONSERVATION'S (SURVEY BRANCH) REQUIREMENT IN POSITION AS DIRECTED BY THE CONSULTING SURVEYOR AND SHOW ON
- WORKS-AS-EXECUTED PLANS. IF REQUIRED - FURTHER INFORMATION MAY BE OBTAINED FROM SMECURBAN
- IF REQUIRED FURTHER INFORMATION MAY BE OBTAINED FROM SMEC DRBAN.
 THE SITE MUST BE ENCLOSED WITH A SUITABLE TEMPORARY 'A CLASS TYPE HOARDING OR SECURITY FENCE
 OF A TYPE APPROVED BY THE CONSENT AUTHORITY. SUCH HOARDING MUST NOT ENCROACH UPON THE
 ROAD RESERVE OR OTHER PRIVATE LAND WITHOUT THE WRITTEN CONCURRENCE OF THE AFFECTED
 PROPERTY OWNER. IF IT IS PROPOSED TO LOCATE SUCH A HOARDING WITHIN ANY PROPERTY OWNED/CONTROLLED BY CAMDEN COUNCIL, A PUBLIC ROAD ACTIVITY APPLICATION MUST BE SUBMITTED TO AND APPROVED BY COUNCIL. PRIOR TO THE HOARDING BEING ERECTED.
- AND APPROVED BY COUNCIL, PRIOR TO THE HOARDING BEING ERECTED.

 CONSTRUCTION ACCESS FROM PUBLIC PLACES IE. ROADS. RESERVES, PARKS, WALKWAYS AND THE LIKE,
 OTHER THAN THAT APPROVED BY THIS DEVELOPMENT CONSENT WILL NOT BE PERMITTED WITHOUT THE
 PRIOR CONSENT OF CAMDEN COUNCIL.

 PRIOR TO THE COMMENCEMENT OF ANY WORK WITHIN THE SITE A SIGN (MINIMUM SIZE OF 300mm X 400mm)
 MUST BE INSTALLED WITHIN THE SITE ADVISING OF THE FOLLOWING:
 14.1. FULL DETAILS OF THE PCA

 14.2. FULL DETAILS OF DEVELOPMENT CONSENT. AND

- 14.3. FULL DETAILS OF DEVELOPMENT CONSENT, AND
- 14.4 EUL DETAILS OF THE BUILDER/CONTRACTOR THE SIGN MUST BE LOCATED WITHIN THE SITE AND CLEARLY VISIBLE AND LEGIBLE FROM THE ROAD FOOTWAY, AND MUST BE DISPLAYED FOR THE

EARTHWORKS NOTES:

- 1. EARTHWORKS ARE TO BE CARRIED OUT TO THE SATISFACTION OF THE COUNCIL. UNSUITABLE MATERIALS ARE TO BE REMOVED FROM ROADS AND LOTS PRIOR TO FILLING. THE CONTRACTOR IS TO ARRANGE AND MAKE AVAILABLE COMPACTION TESTING RESULTS FOR ALL AREAS THAT CONTAIN FILL IN EXCESS OF 200r
- MAKE AVAILABLE COMPACTION TESTING RESULTS FOR ALL AREAS THAT CONTAIN FILL IN EXCESS OF 200mm. COMPACTION OF EARTHWORKS SHALL CONTINUE UNTIL A DRY DENSITY RATIO OF 95% FOR SITE FILLING AND 100% FOR ROAD PAVEMENT SUBGRADES HAS BEEN ACHIEVED IN ACCORDANCE WITH TEST METHOD AS1289.5.3.1 OR AS1289.5.1.1 THE CONTROL TESTING OF EARTHWORKS SHALL BE IN ACCORDANCE WITH THE GUIDELINES IN AS378% GUIDELINES ON EARTHWORKS FOR COMMERCIAL AND RESIDEDITIAL DEVELOPMENTS'. WHERE IT IS PROPOSED TO USE TEST METHOD AS1289.5.8.1 TO DETERMINE THE FIELD DENSITY, A SAND REPLACEMENT METHOD SHALL BE USED TO CONFIRM THE RESULTS.
- REPLACEMENT METHOD SHALL BE USED TO CONFIRM THE RESULTS.

 THE SUITABLE QUALIFIED GEOTECHNICAL ENGINEER, SHALL HAVE A LEVEL 1 RESPONSIBILITY FOR ALL FILLING
 AS DEFINED IN APPENDIX B AS3798 GUIDELINES ON EARTHWORKS FOR COMMERCIAL AND RESIDENTIAL
 DEVELOPMENTS, AND AT THE END OF THE WORKS SHALL CONFIRM THE EARTHWORKS COMPLY WITH THE
 REQUIREMENTS OF THE SPECIFICATION AND DRAWINGS BY WRITTEN NOTIFICATION.
 IN AREAS TO BE FILLED WHERE THE SLOPE OF THE NATURAL SURFACE EXCEEDS 1(V):4(H), BENCHES ARE TO
 BE CUT TO PREVENT SLIPPING OF THE PLACED FILL MATERIAL AS REQUIRED BY THE COUNCIL.
- ALL BATTERS ARE TO BE SCARIFIED TO A DEPTH OF 50mm TO ASSIST WITH ADHESION OF TOP SOIL TO BATTER
- 6. PROVIDE MINIMUM 150mm AND MAXIMUM 300mm TOPSOIL WITH ON FOOTPATHS, FILLED AREAS AND ALL OTHER AREAS DISTURBED DURING CONSTRUCTION, TOPSOILED AREAS TO BE STABILISED WITH APPROVED VEGETATION A MAXIMUM OF 14 DAYS AFTER TOPSOILING AND ARE TO BE WATERED TO ENSURE
- VEGETATION A MACRIMUM OF THE DATE OF THE CONTROL SECTION OF THE CONTROL SHALL CONTROL SEDIMENTATION, EROSION AND POLLUTION DURING CONSTRUCTION IN ACCORDANCE WITH THE REQUIREMENTS OF THE CURRENT EDITION OF MANAGING URBAN STORMWATER: SOILS AND CONSTRUCTION PRODUCED BY LANDCOM.
- A MINIMUM 1 METRE WIDE, CONTINUOUS STRIP OF COUCHGRASS SHALL BE PLACED BEHIND THE BACK OF ALL KERBS AND OTHER CONCRETE STRUCTURES IMMEDIATELY AFTER THE COMPLETION OF THE FOOTPATH GRADING OR OTHER ELEMENTS AS APPLICABLE, AND SHALL BE MAINTAINED AND REPLACED AS REQUIRED. DURING THE CONSTRUCTION MAINTENANCE PERIOD AND MAINTENANCE PERIODS

SERVICES NOTES:

- SERVICE CONDUITS TO BE PLACED AS DIRECTED BY ENDEAVOUR, NBN CO. AND AS REQUIRED BY SYDNEY
- WATER CORPORATION.
 2. SERVICES SHOWN HEREON HAVE BEEN LOCATED WHERE POSSIBLE BY FIELD SURVEY, IF NOT ABLE TO BE SERVICES SHOWN HEREON MAYE BEEN LOCATED WHERE POSSIBLE BY FIELD SURVEY. IF NOT ABLE TO BE LOCATED SERVICES HAVE BEEN PLOTTED FROM THE RECORDS OF RELEVANT AUTHORITIES WHERE AVAILABLE AND HAVE BEEN NOTED ACCORDINGLY ON THIS PLAN. WHERE SUCHRECORDS EITHER DO NOT EXIST OR ARE INADECUATE A NOTATION HAS BEEN MADE HEREON, PRIOR TO ANY DEMOLITION, EXCAVATION OR CONSTRUCTION ON THE SITE, THE RELEVANT AUTHORITY SHOULD BE CONTACTED FOR POSSIBLE

REPAIR ANY DAMAGE TO EXISTING SURFACE

- LOCATION OF FURTHER UNDERGROUND SERVICES & DETAILED LOCATIONS OF ALL SERVICES. PUBLIC UTILITY SERVICES ARE TO BE ADJUSTED AS NECESSARY. PROPOSED SERVICE CROSSING TO BE THRUST BORED UNDER EXISTING ROAD PAVEMENT. CONTRACTOR TO
- REPAIR ANY DAMAGE TO EXISTING SURFACE.
 ALL SYDNEY WATER HYDRANTS ARE TO BE CLEARLY IDENTIFIABLE BY APPROPRIATE KERB MARKINGS AND
 BLUE COLOURED RAISED REFLECTIVE PAVEMENT MARKERS PLACED AT THE CENTRELINE OF THE ROAD
 OPPOSITE THE HYDRANT. THESE PAVEMENT MARKERS ARE TO BE REINSTATED AFTER PLACEMENT OF THE
 FINAL LAYER OF ASPHALTIC CONCRETE AND PRIOR TO THE RELEASE OF THE ROAD SURFACING BOND.
 CONTRACTOR TO INSTALL ELECTRICAL, NBN AND GAS DUCT CROSSINGS TO RELEVANT AUTHORITY
 STANDARDS. CONTRACTOR TO SURVEY & CERTIFY COVER TO EACHROAD DUCT CROSSING AS GIVEN ON THE
 ADDROVED IS CONTRACTOR TO ALLAY LEVEL & CERTIFY COVER TO EACHROAD DUCT CROSSING AS
- APPROVED ELECTRICAL PLAN. LEVELS & CERTIFICATION TO BE PROVIDED TO SMEC URBAN FOR CONFORMATION AND SUBMISSION OF WAE LEVELS TO ENDEAVOUR ENERGY FOR CERTIFICATION.
 ALTERNATIVELY, CONTACT SMEC URBAN ONE DAY PRIOR TO TRENCH BEING OPEN AND/OR BACKFILLED FOR

ROADWORKS NOTES:

- 1. SUBGRADES AND SUB BASES ARE TO BE COMPACTED IN ACCORDANCE WITH COUNCIL'S CONSTRUCTION
- SUBSOIL DRAINS TO BE PROVIDED ON BOTH SIDES OF ROADS (EXCEPT WHERE THERE IS STORMWATER
- LITATIVAGE).

 150 x 50 H.D. GALVANISED STEEL KERB OUTLETS TO BE PLACED IN ALL KERB TYPES ON L OW SIDE OF LOTS. PROVIDE SUITABLE ADAPTOR TO ALL.O.W. CONNECTION OF 90mm DIAMETER STORMWATER PIPE. LIPLESS PERAMBULATOR CROSSINGS ARE TO BE PROVIDED IN ALL KERB RETURNS AND WHERE REQUIRED BY COUNCIL.
- 5. SERVICE CONDUITS TO BE PLACED AS DIRECTED BY ALL PUBLIC UTILITY AUTHORITIES INCLUDING ENDEAVOUR ENERGY, NBN CO, AND SYDNEY WATER
- PROPOSED UTILITIES AND SERVICES CROSSING EXISTING ROADS SHALL BE PROVIDED FOR USING A TRENCHLESS TECHNIQUE SO AS NOT TO DAMAGE THE EXISTING SURFACE, ALL SERVICE CONDUITS UNDER ROADS MUST BE LAID TO A MINIMUM DEPTH OF 750mm
- CONCRETE FOOTPATH CONSTRUCTION IS TO BE BONDED WITH COUNCIL PENDING COMPLETION OF UTILITY/SERVICES AND SURROUNDING DWELLINGS.

 ALL TEMPORARY ROADS MUST BE TEMPORARILY SEALED WITH A SINGLE COAT FLUSH SEAL.
- ALL PERMANENT ROADS MUST BE SEALED WITH A SINGLE COAT FLUSH SEAL AND 50mm OF AC TO BE APPLIED IN TWO 25mm THICK LAYERS. THE FINAL AC LAYER IS TO BE AC 10 AND IS TO BE BONDED AND PLACED FOLLOWING APPROVAL FROM COUNCIL.
- 10. SIGNPOSTING AND LINE MARKING SHALL CONFORM TO AS1742.2 TRAFFIC CONTROL DEVICES FOR GENERAL JOSE: ANSED RETRO-REFLECTIVE PAVEMENT MARKERS TO CONFORM TO AS1 906 RETRO-REFLECTIVE WATERIALS AND DEVICES FOR ROAD TRAFFIC CONTROL PURPOSES: ALL APRONS AND KERB FACE ON CENTRAL ISLANDS OF ROUNDABOUTS AND AND AND AND AND KERB FACE ON CENTRAL ISLANDS OF ROUNDABOUTS AND ALL APRONS AND KERB FACE ON CENTRAL ISLANDS OF ROUNDABOUTS AND ALL OTHER ISLANDS TO BE DELINEATED BY RELECTIVE WHITE MARKING, INSTALLATION SHALL OCCUR IN ACCORDANCE WITH THE PLAN APPROVED BY THE LOCAL TRAFFIC
- 11. ALL LOT AND HOUSE NUMBERS MUST BE STENCILED ON KERB FACE
- 12. STREET SIGNS TO COUNCIL STANDARD MUST BE INSTALLED BY THE CONTRACTOR.

STORMWATER NOTES:

- ALL PIPES TO BE SPIGOT AND SOCKET, RUBBER RING JOINTED.
 ALL LONGITUDINAL PIPELINES IN ROADS MUST BE LOCATED UNDER KERB AND GUTTER AND BE BACKFILLED WITH APPROVED GRANULAR MATERIAL UNLESS OTHERWISE APPROVED BY THE COUNCIL ENGINEER.
- 3. DRAINAGE LINES MUST BE BACKFILLED WITH APPROVED GRANULAR MATERIAL IN TRAFFICABLE AREAS THREE (3) METRES OF SUBSOIL DRAINAGE WRAPPED IN GEOTEXTILE STOCKING MUST BE PROVIDED TO ALL DOWNSTREAM PITS
- ALL GULLY PITS TO COUNCIL'S STANDARD AND LINTELS CENTRALLY PLACED AT SAG PITS
- ALL PITS MUST BE BENCHED AND STREAMLINED. PROVIDE \$1.72 REINFORCEMENT AND GALVANISED STEP IRONS IN ALL PITS OVER 1.2 METRES DEEP AS MEASURED FROM THE TOP OF GRATE TO THE INVERT OF THE
- 6. CONCRETE IS TO HAVE MINIMUM COMPRESSIVE STRENGTH OF 32MPa AT 28-DAYS UNLESS OTHERWISE APPROVED BY THE COUNCIL ENGINEER.
- 7. ALL INTERALLOTMENT DRAINAGE MUST HAVE A MINIMUM PIPE DIAMETER OF 150 mm AND A MINIMUM GRADE


- ALL INTERALLOT MENT DRAINAGE MUST HAVE A MINIMUM PIPE DIAMETER OF 150 mm AND A MINIMUM GRADE OF 1% UNLESS OTHERWISE APPROVED BY THE COUNCIL ENGINEER.

 ALL INTERALLOTMENT DRAINAGE LINES MUST BE LAID CENTRALLY WITHIN DRAINAGE EASEMENTS. INSPECTION PITS MUST BE PROVIDED AT ALL CHANGES OF GRADE AND DIRECTION.

 INTERALLOTMENT DRAINAGE LINES MUST BE INSTALLED AFTER SYDNEY WATER SEWERAGE LINES HAVE BEEN INSTALLED WHERE SEWER IS PROPOSED ADJACENT TO INTERALLOTMENT DRAINAGE LINES. 10. 1% AEP OVERLAND FL.O.W. PATHS MUST BE FORMED AND SHOWN ON 'WORKS AS EXECUTED' DRAWINGS.
- 11. ALL PLANS (BOTH DESIGN AND WAE) ARE TO CLEARLY DELINEATE THE EXTENT/LOCATION OF FLOOD LINES
- INCLUDING THE 5% AFP. 1% AFP AND PMF. 12. ADEQUATE PROVISION IS TO BE MADE TO PREVENT SCOURING AND SEDIMENTATION FOR ALL DRAINAGE
- WORKS IN ACCORDANCE WITH COUNCIL'S REQUIREMENTS.
 PIT LINTELS ARE TO BE STENCILED WITH APPLICABLE DISTINCTION STENCIL AVAILABLE FROM COUNCIL.
 CATCHDRAINS MUST BE CONSTRUCTED AS REQUIRED BY THE APPROVED PLANS OR THE PRINCIPAL
- 15. SOIL AND WATER MANAGEMENT PLANS ARE TO BE PREPARED FOR ALL DISTURBED SITES AND ADHERED TO
- AT ALL TIMES DURING THE CONSTRUCTION AND MAINTENANCE PERIODS.

GEOTECHNICAL NOTES:

- THE CONTRACTOR SHALL IMPLEMENT EROSION AND SEDIMENT CONTROL MEASURES AS NECESSARY, AND TO THE SATISFACTION OF COUNCIL PRIOR TO THE COMMENCEMENT OF CONSTRUCTION AND DURING CONSTRUCTION. MAINTENANCE OF THE EROSION AND SEDIMENT CONTROL IS TO BE UNDERTAKEN ON A REGULAR BASIS & AS PER COUNCIL'S DIRECTION.
- TESTS SHALL BE UNDERTAKEN ON ANY PROPOSED FILL MATERIALS TO ENSURE THAT THE DO NOT HAVE A
- TESTS SHALL BE UNDERTAKEN ON ANY PROPOSED FILL MATERIALS TO ENSURE THAT THE DO NOT HAVE A HIGH DISPERSION POTENTIAL AS DEFINED BY THE EMERSON CRUMBIOISPERSION TESTS (AS1289 C.8-1980). ALL FILL SHALL BE COMPACTED TO NOT LESS THAN 95% OF STANDARD MAXIMUM DRY DENSITY AT .3% TO +3% OF STANDARD OPTIMUM MOISTURE CONTENT (MAXIMUM FILL HORIZONS OF 150 mm TO 200mm). ALL AREAS WHICHHAVE TEST RESULTS LESS THAN 95% STANDARD SHOULD BE REWORKED AND RETESTED TO ENSURE COMPLIANCE, IN ACCORDANCE WITH A.S.A. 1289 TESTS 12 AND 13. ALL FILL SHALL BE COMPACTED AT 100% OF STANDARD AND TESTED IN ACCORDANCE WITH CAMDEN COUNCILS DRAFT ENGINEERING CONSTRUCTION SPECIFICATION MAY 2003, ASSOCIATED GUIDELINES AND THE MOST CLUPDANT EDITION AS 4305. SUCH TESTING TO BE LINDEDTAKED BY A NATA DEGISTEDED.
- THE MOST CURRENT EDITION AS 1289; SUCH TESTING TO BE UNDERTAKEN BY A NATA REGISTERED
- ALL FILL AREAS TO BE SURVEYED AT STRIPPING AND FINAL STAGES AND LEVELS SHOWN ON PLAN SHADED. (TOGETHER WITH CROSS SECTIONS AT MAXIMUM 20m C/C) AT WORKS-AS-EXECUTED STAGE AND CONTROLLED BY A REGISTERED SURVEYOR. 88B INSTRUMENT REQUIRED FOR ALL LOTS FILLED WITHIN THE
- ALL EARTHWORKS SHALL BE CONTROLLED AND CERTIFIED BY A N.A.T.A. REGISTERED LABORATORY. TWO COLLATED COPIES OF ALL TEST CERTIFICATES, ACCOMPANIED BY AN OVERALL SITE PLAN, CLEARLY INDICATING THE LOCATION OF EACHTEST AND FILL AREAS ETC., AND THE LABORATORY CERTIFICATE COVERING THE WHOLE OF THE AREA TESTED ARE TO BE FORWARDED TO COUNCIL UPON COMPLETION
- TESTING IS TO BE TO LEVEL 1 ASS798 APPENDIX B2(A).
 ALL RESIDENTIAL LOTS SHALL BE INDIVIDUALLY CLASSIFIED IN ACCORDANCE WITH THE LATEST EDITION OF THE GUIDELINES IN THE AUSTRALIAN STANDARD FOR RESIDENTIAL SLABS AND FOOTINGS AS 2870. PROVIDE TWO COPIES OF REPORT TO COUNCIL.

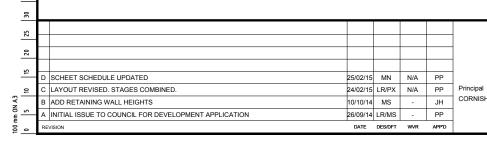



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PARFENON J. HYNES

M. NEILSON . PARFENOW

P. G. McNAMARA

SEPTEMBER 2014

Authorised

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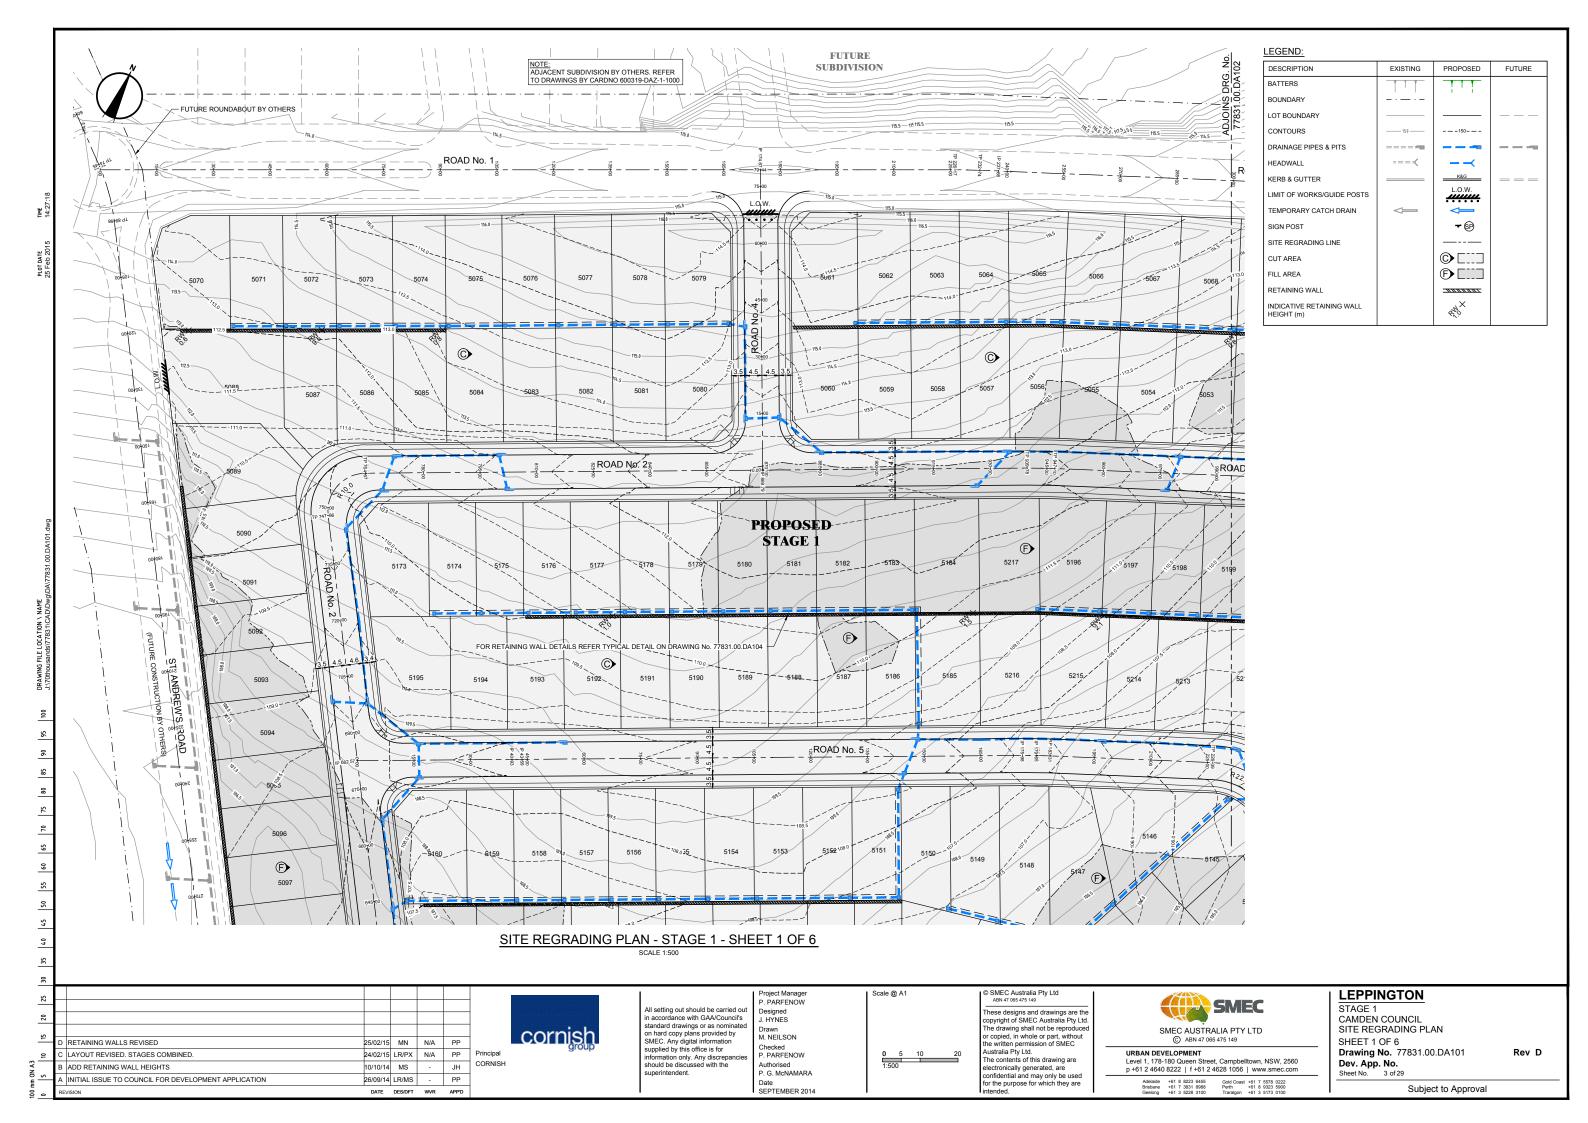
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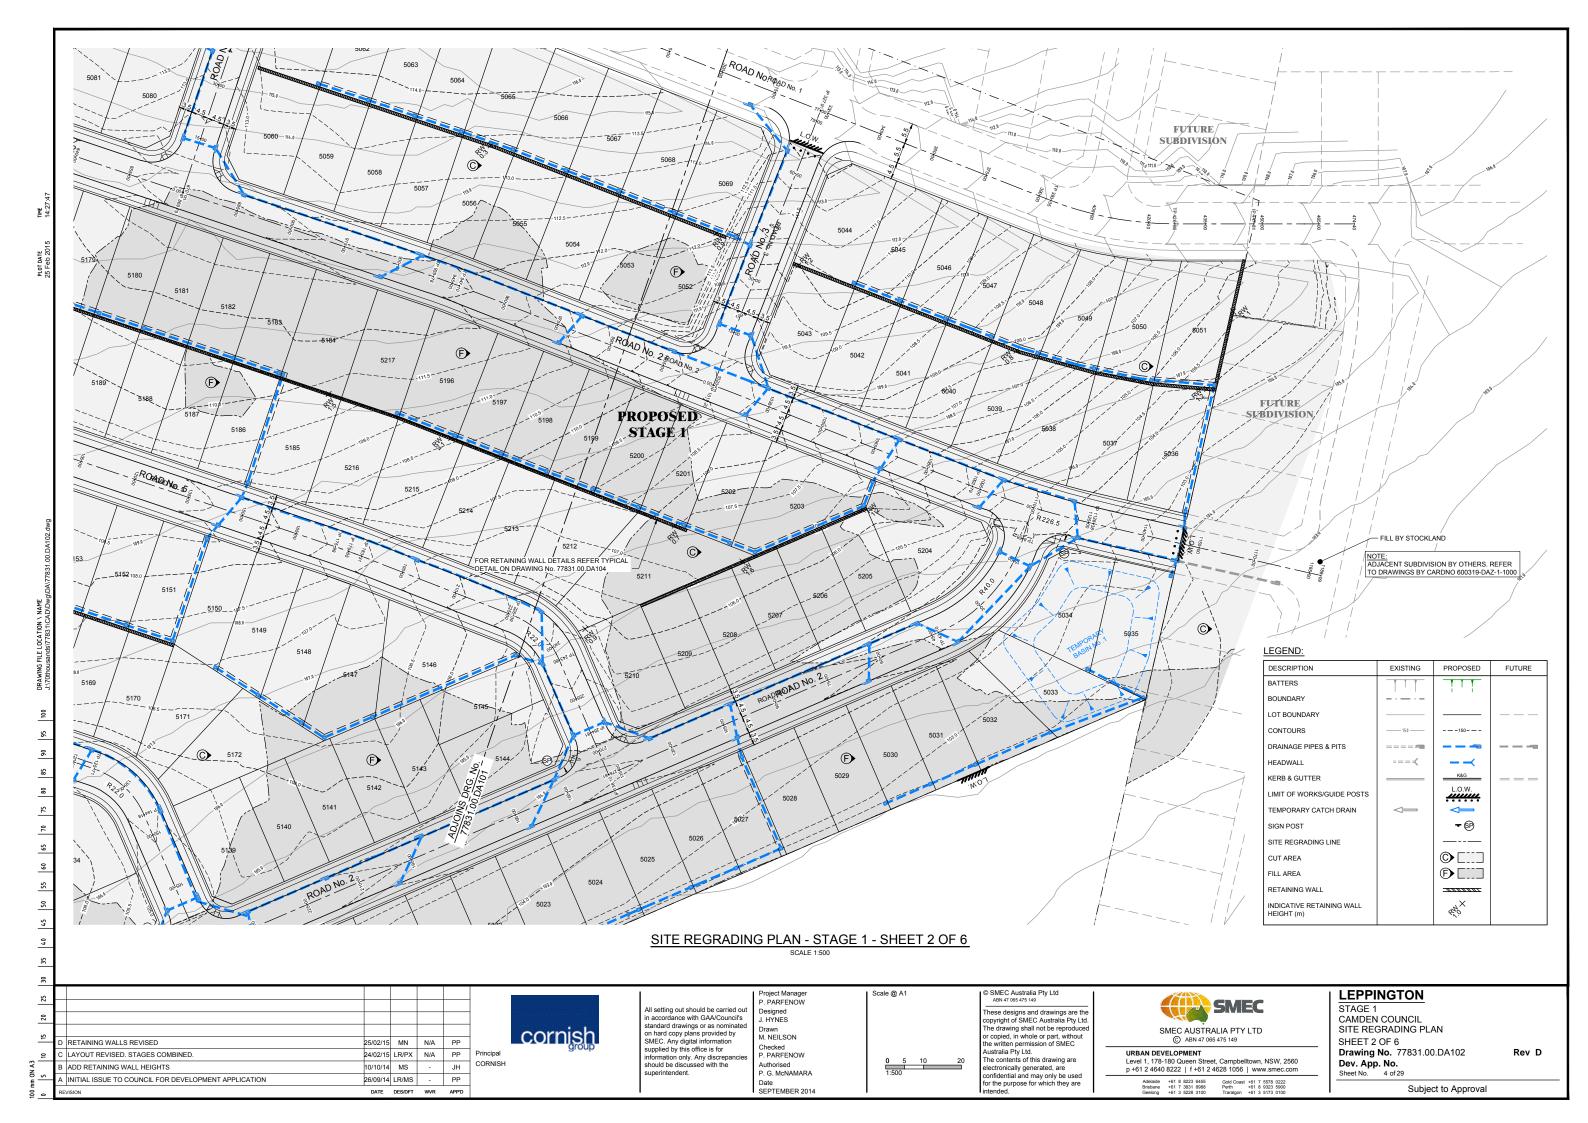
LEPPINGTON STAGE 1 CAMDEN COUNCIL


SHEET SCHEDULE & NOTES Drawing No. 77831.00.DA002


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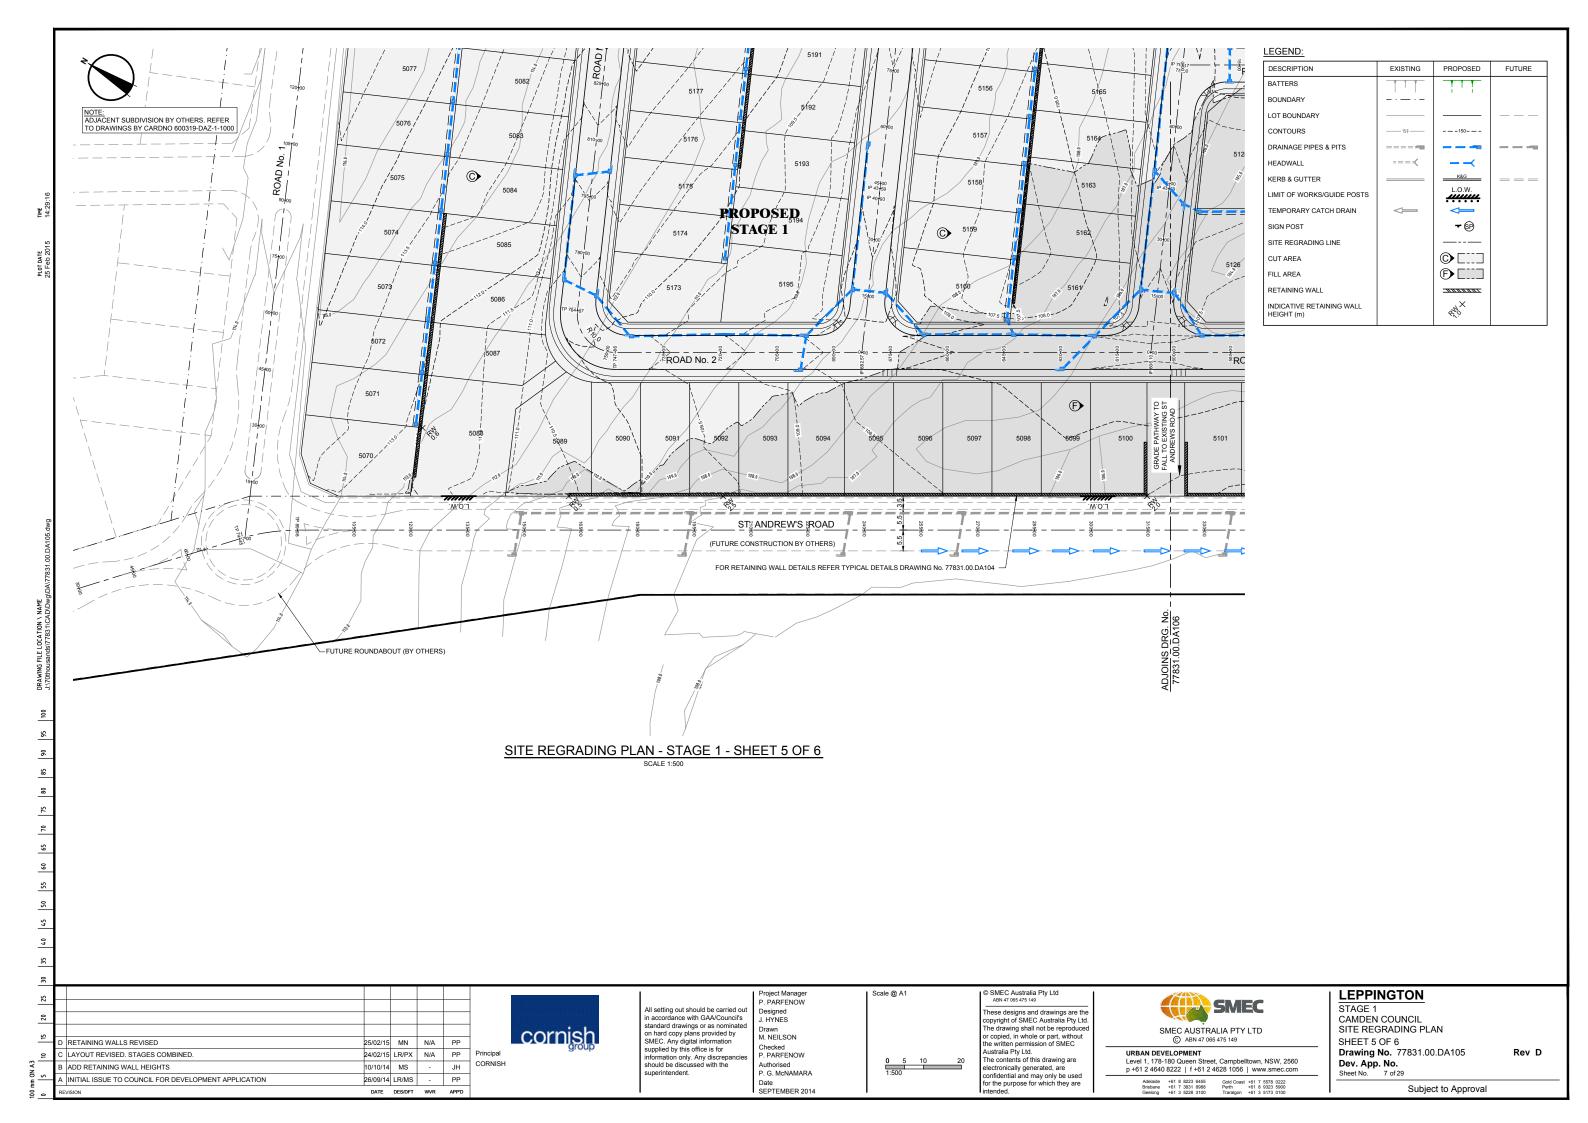
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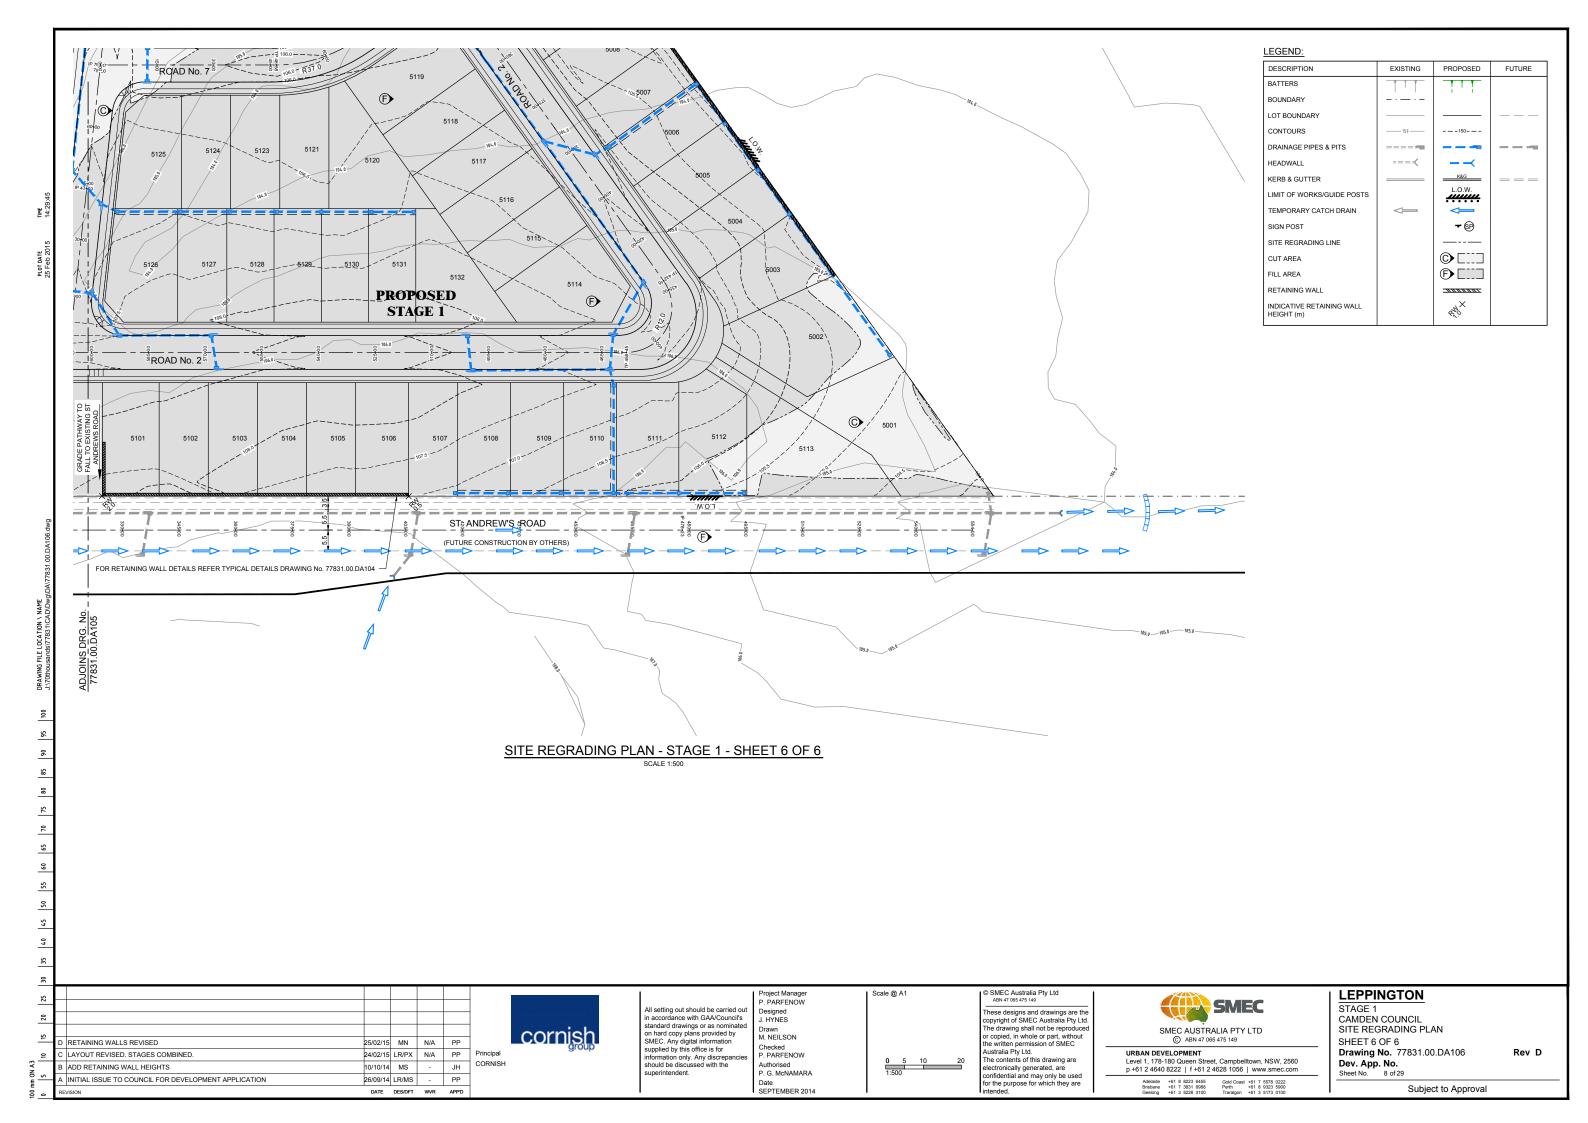











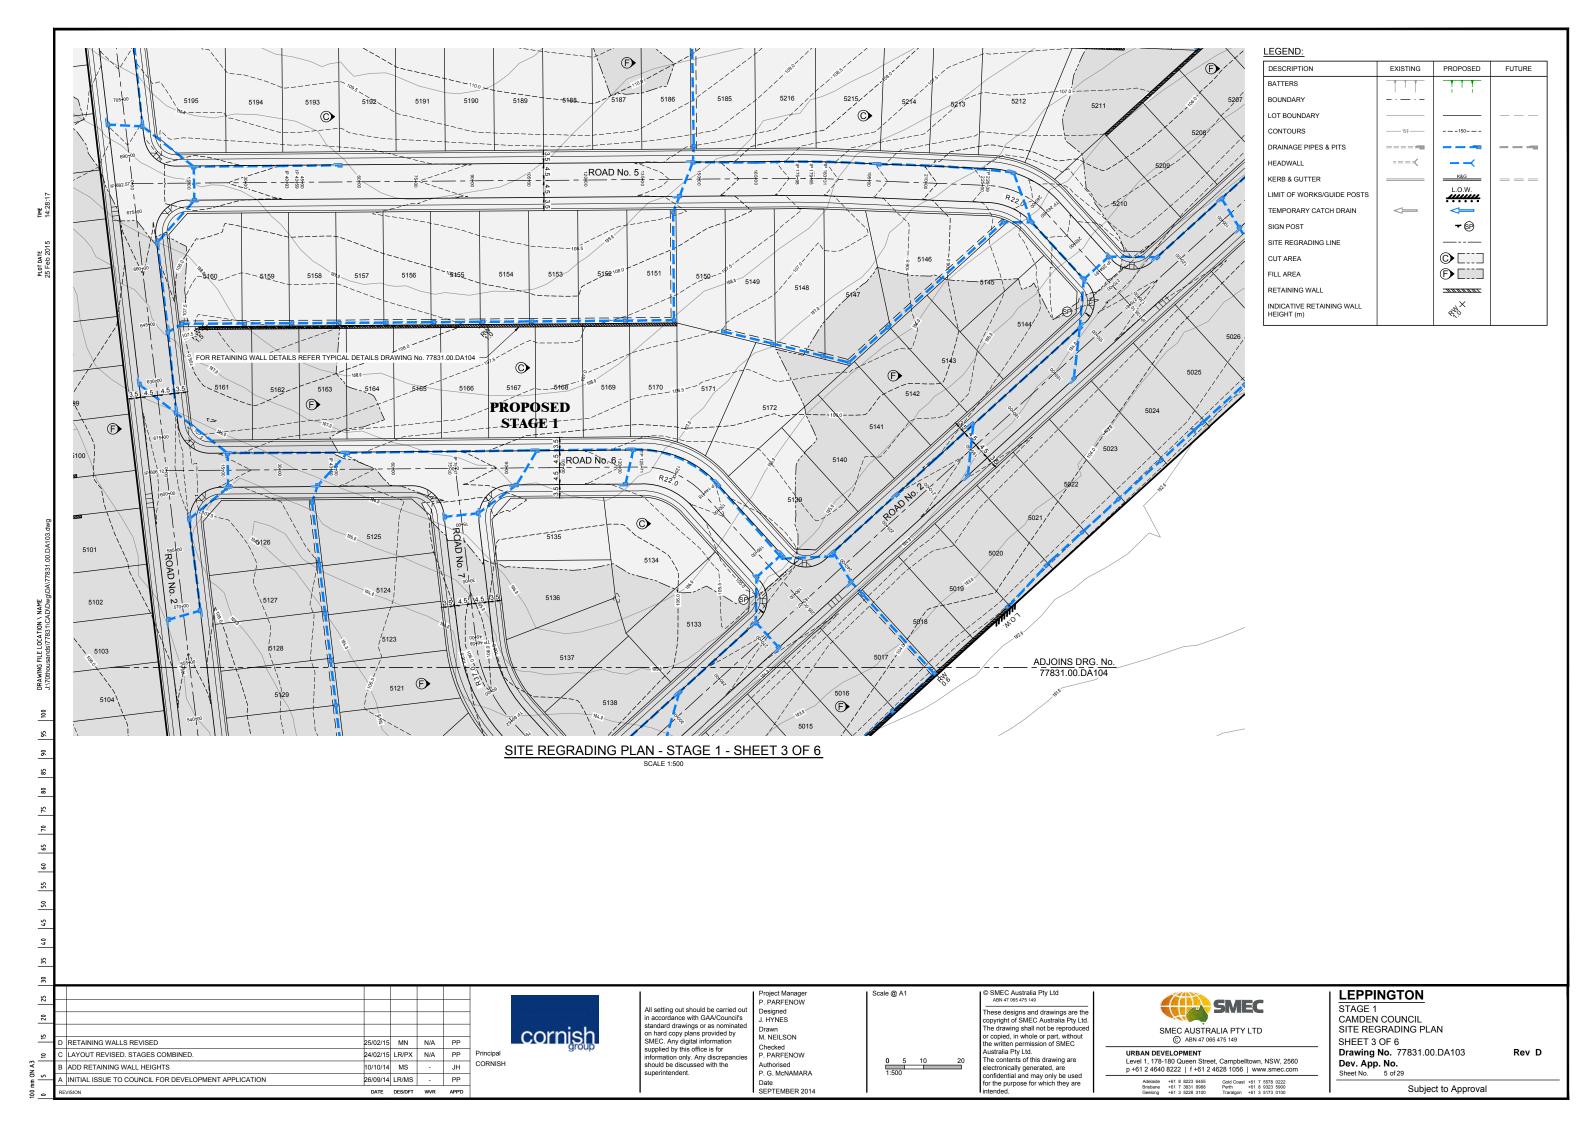


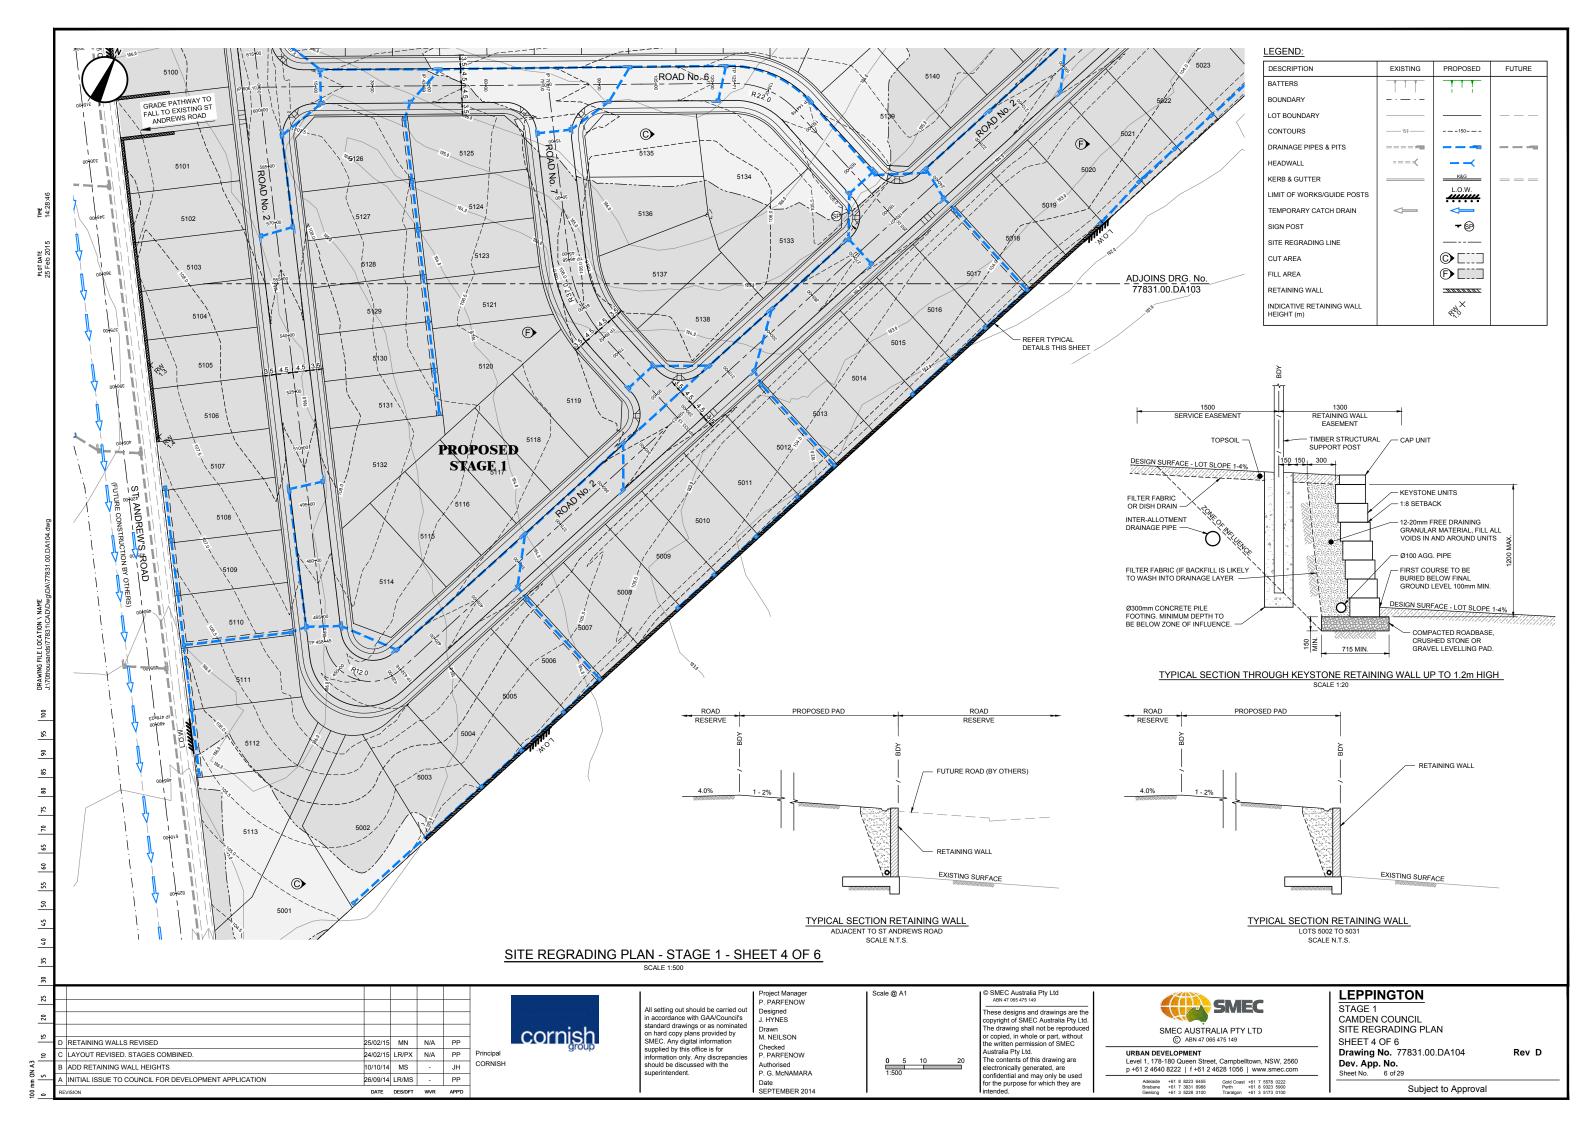

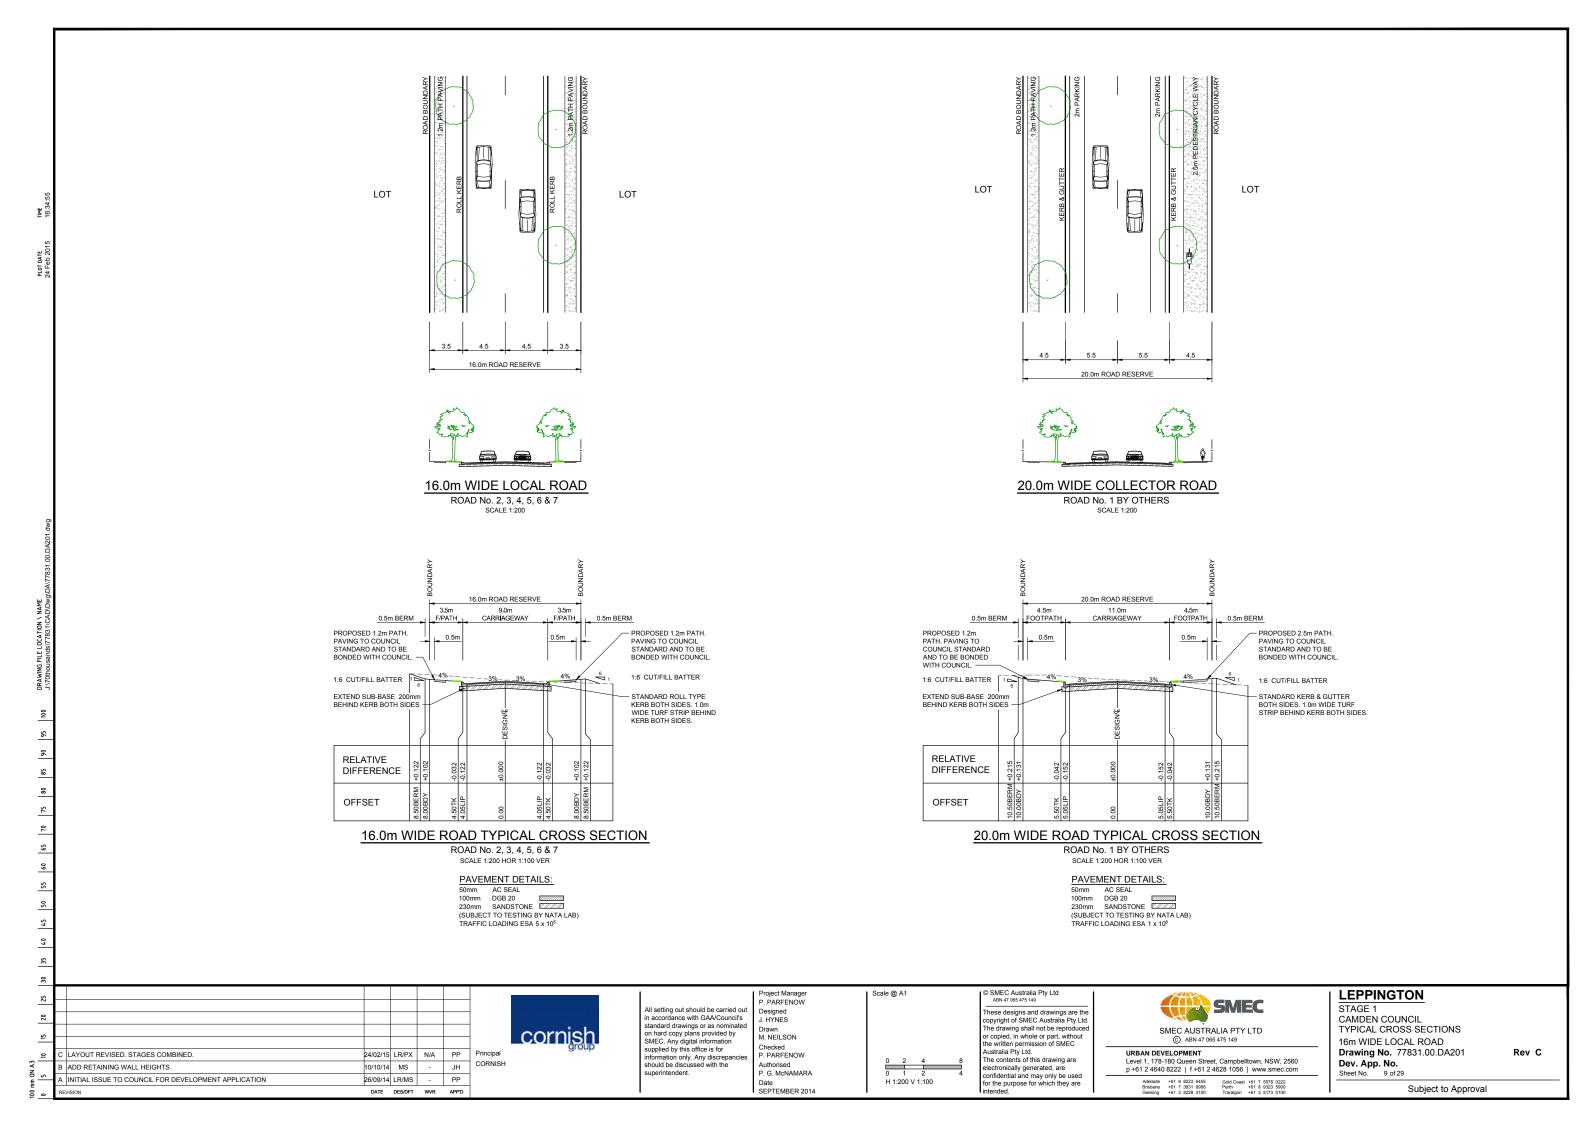

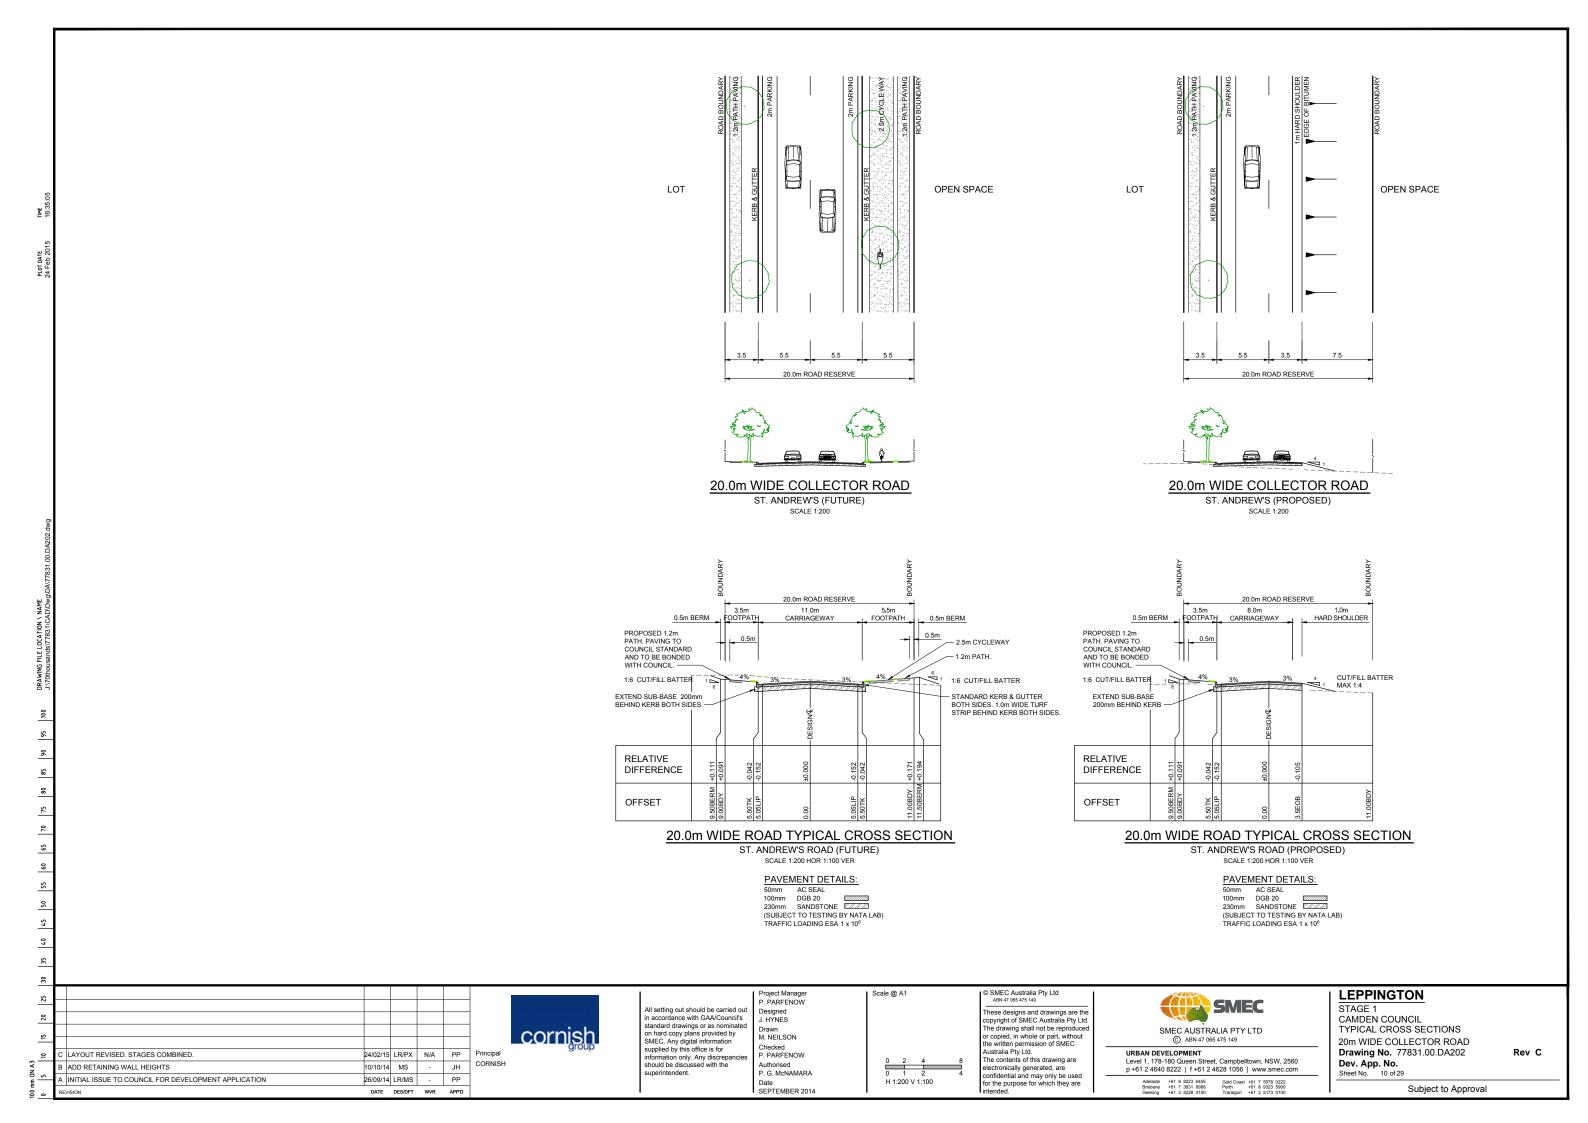

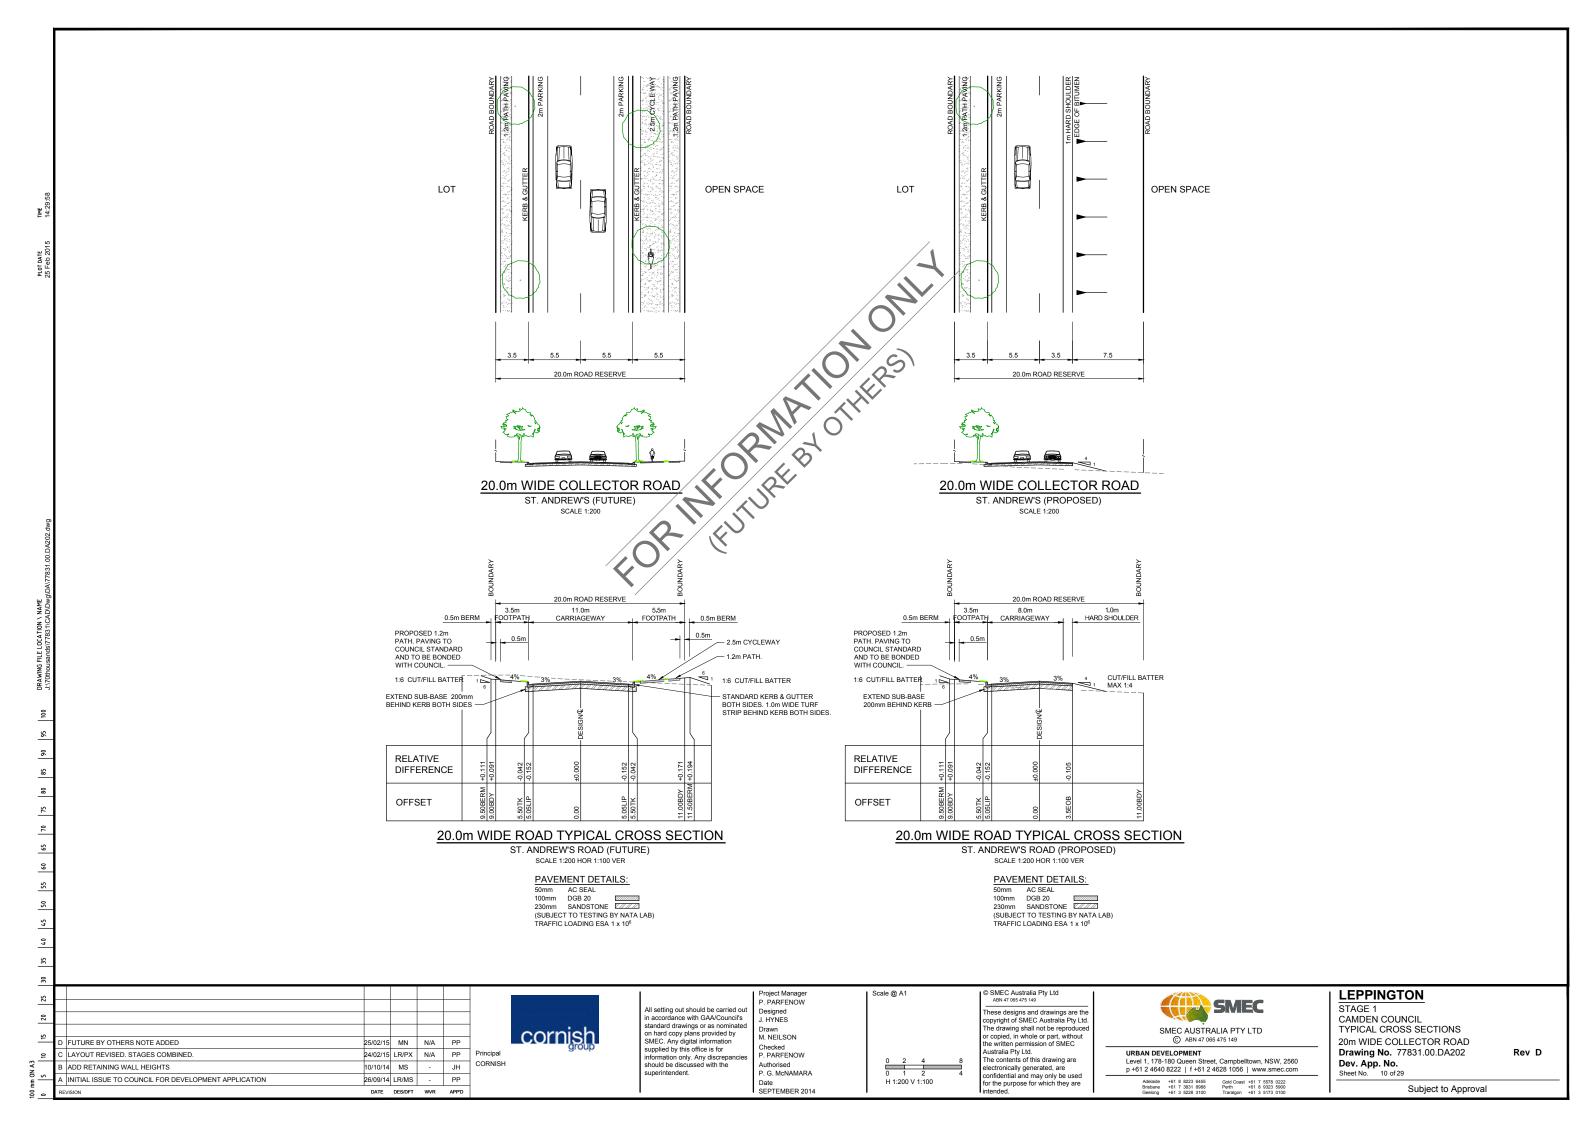

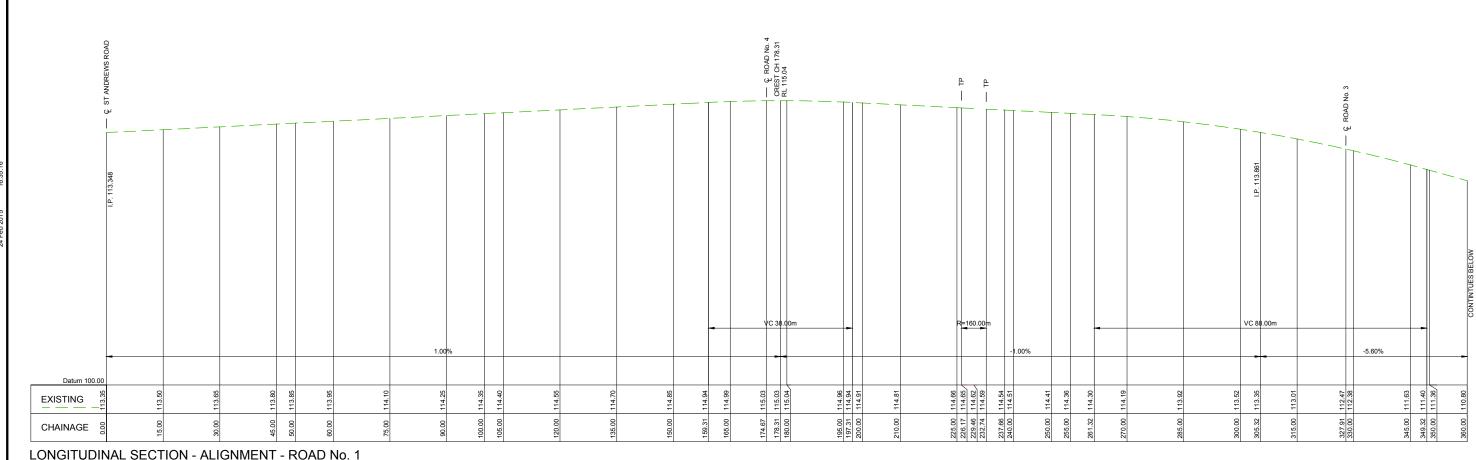

LONGITUDINAL SECTION - ALIGNMENT - ROAD No. 1

R=90.00m

LONGITUDINAL SECTION - ALIGNMENT - ROAD No. 1

24/02/15 LR/PX N/A PP Principal CORNISH C LAYOUT REVISED. STAGES COMBINED. B ADD RETAINING WALL HEIGHTS A INITIAL ISSUE TO COUNCIL FOR DEVELOPMENT APPLICATION 26/09/14 LR/MS - PP DATE DES/DFT WVR APP'D



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Designed J. HYNES Drawn M. NEILSON Checked P. PARFENOW Authorised P. G. McNAMARA Date SEPTEMBER 2014

P. PARFENOW

Scale @ A1

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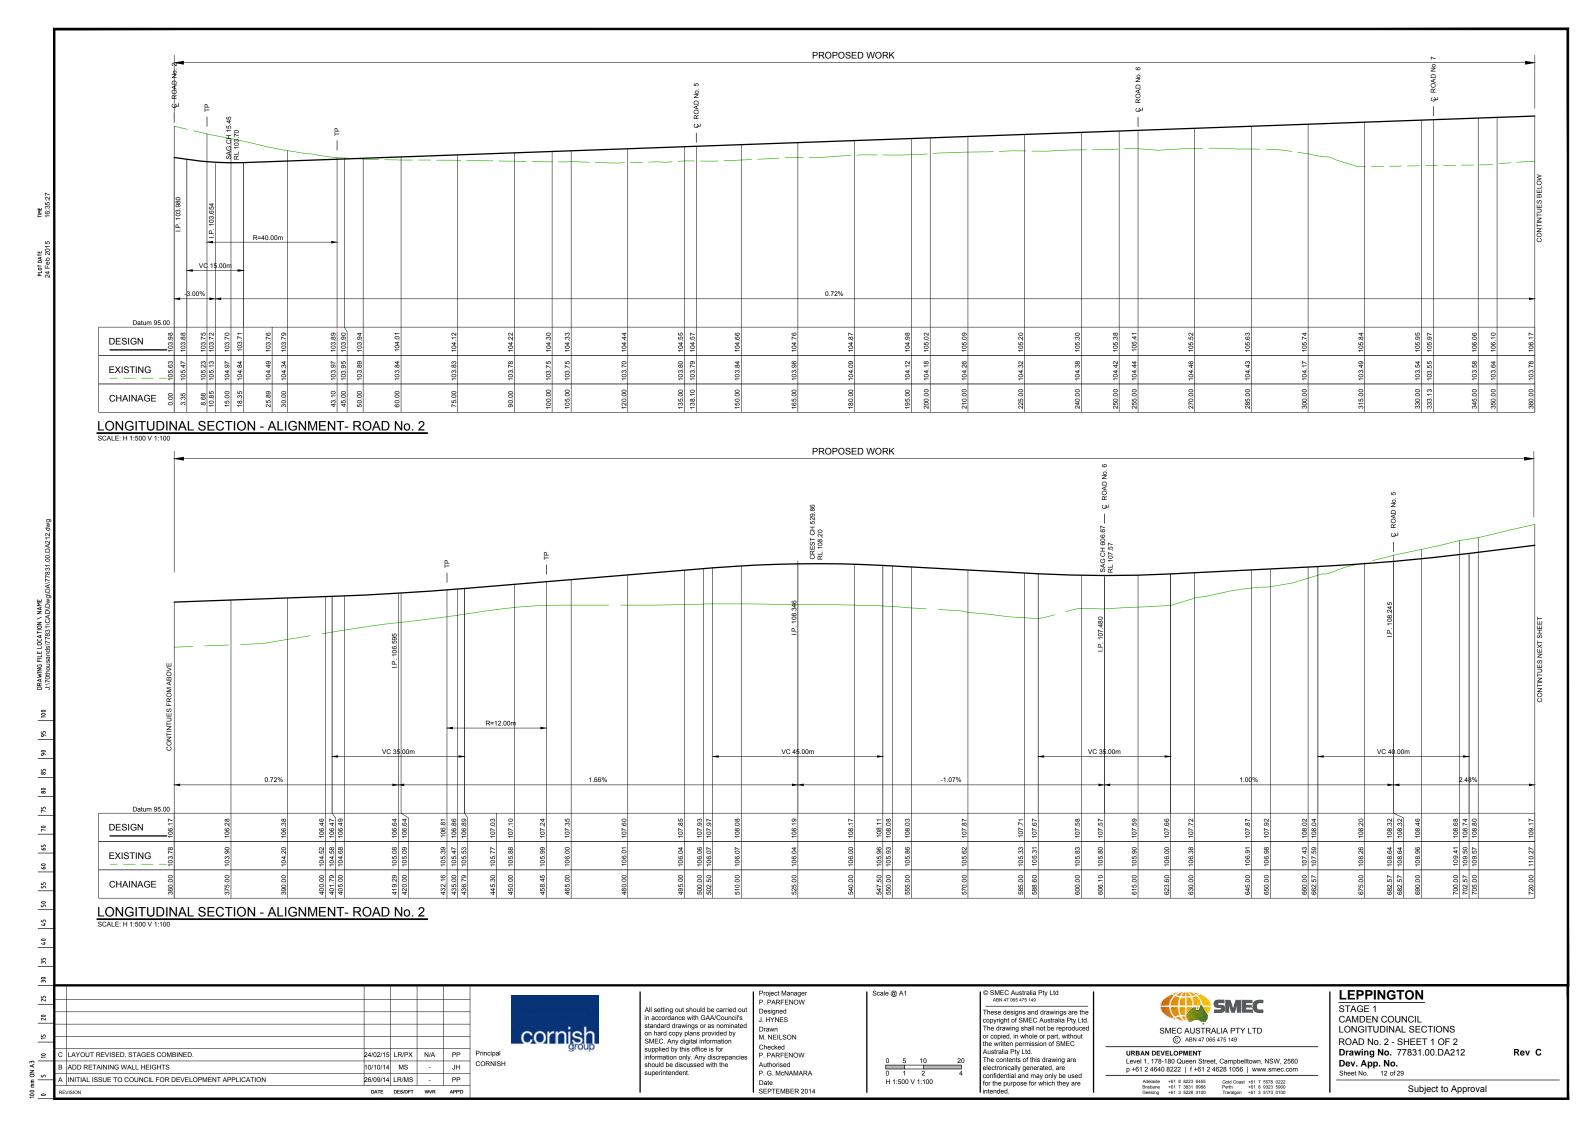
STAGE 1 CAMDEN COUNCIL LONGITUDINAL SECTIONS ROAD No. 1


Drawing No. 77831.00.DA211 Dev. App. No.

Subject to Approval

Rev C

-5.60% Datum 100.00 105.88 **EXISTING** CHAINAGE



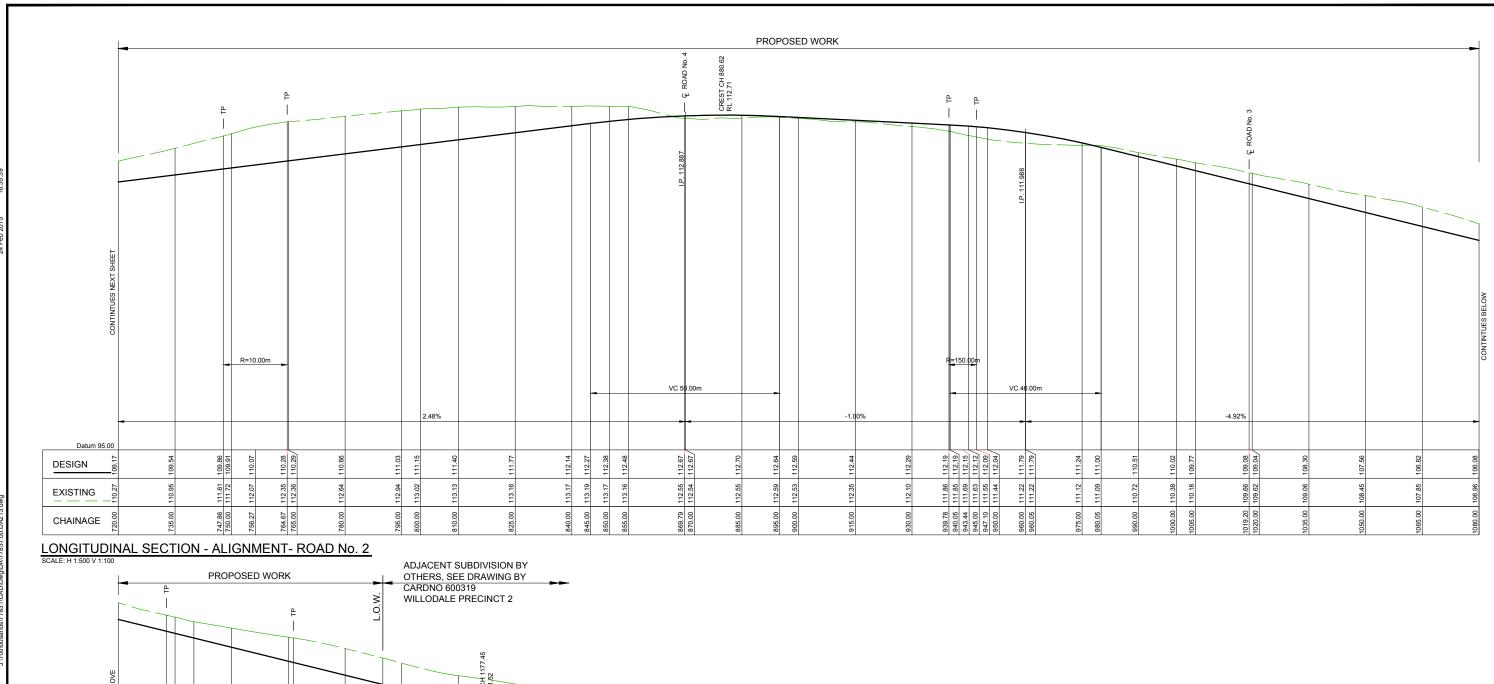

VC 15.00m -4.92% Datum 95.00 101.66 DESIGN 102.73 102.66 102.54 **EXISTING** CHAINAGE

26/09/14 LR/MS - PP

DATE DES/DFT WVR APP'D

LONGITUDINAL SECTION - ALIGNMENT- ROAD No. 2

A INITIAL ISSUE TO COUNCIL FOR DEVELOPMENT APPLICATION

LAYOUT REVISED, STAGES COMBINED.

B ADD RETAINING WALL HEIGHTS

cornish 24/02/15 LR/PX N/A PP Principal 10/10/14 MS - JH CORNISH

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P. PARFENOW Designed J. HYNES Drawn M. NEILSON Checked P. PARFENOW Scale @ A1

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LEPPINGTON STAGE 1


CAMDEN COUNCIL LONGITUDINAL SECTIONS ROAD No. 2 - SHEET 2 OF 2 **Drawing No.** 77831.00.DA213


Dev. App. No.


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Rev C


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Level 1, 178-180 Queen Street, Campbelltown, NSW, 2560 p +61 2 4640 8222 | f +61 2 4628 1056 | www.smec.com Authorised P. G. McNAMARA Adelaide +61 8 8223 6455 Gold Coast +61 7 5578 0222 Brisbane +61 7 3831 8988 Perth +61 8 9323 5900 Geelong +61 3 5228 3100 Transloon +61 3 5173 0100 Date SEPTEMBER 2014



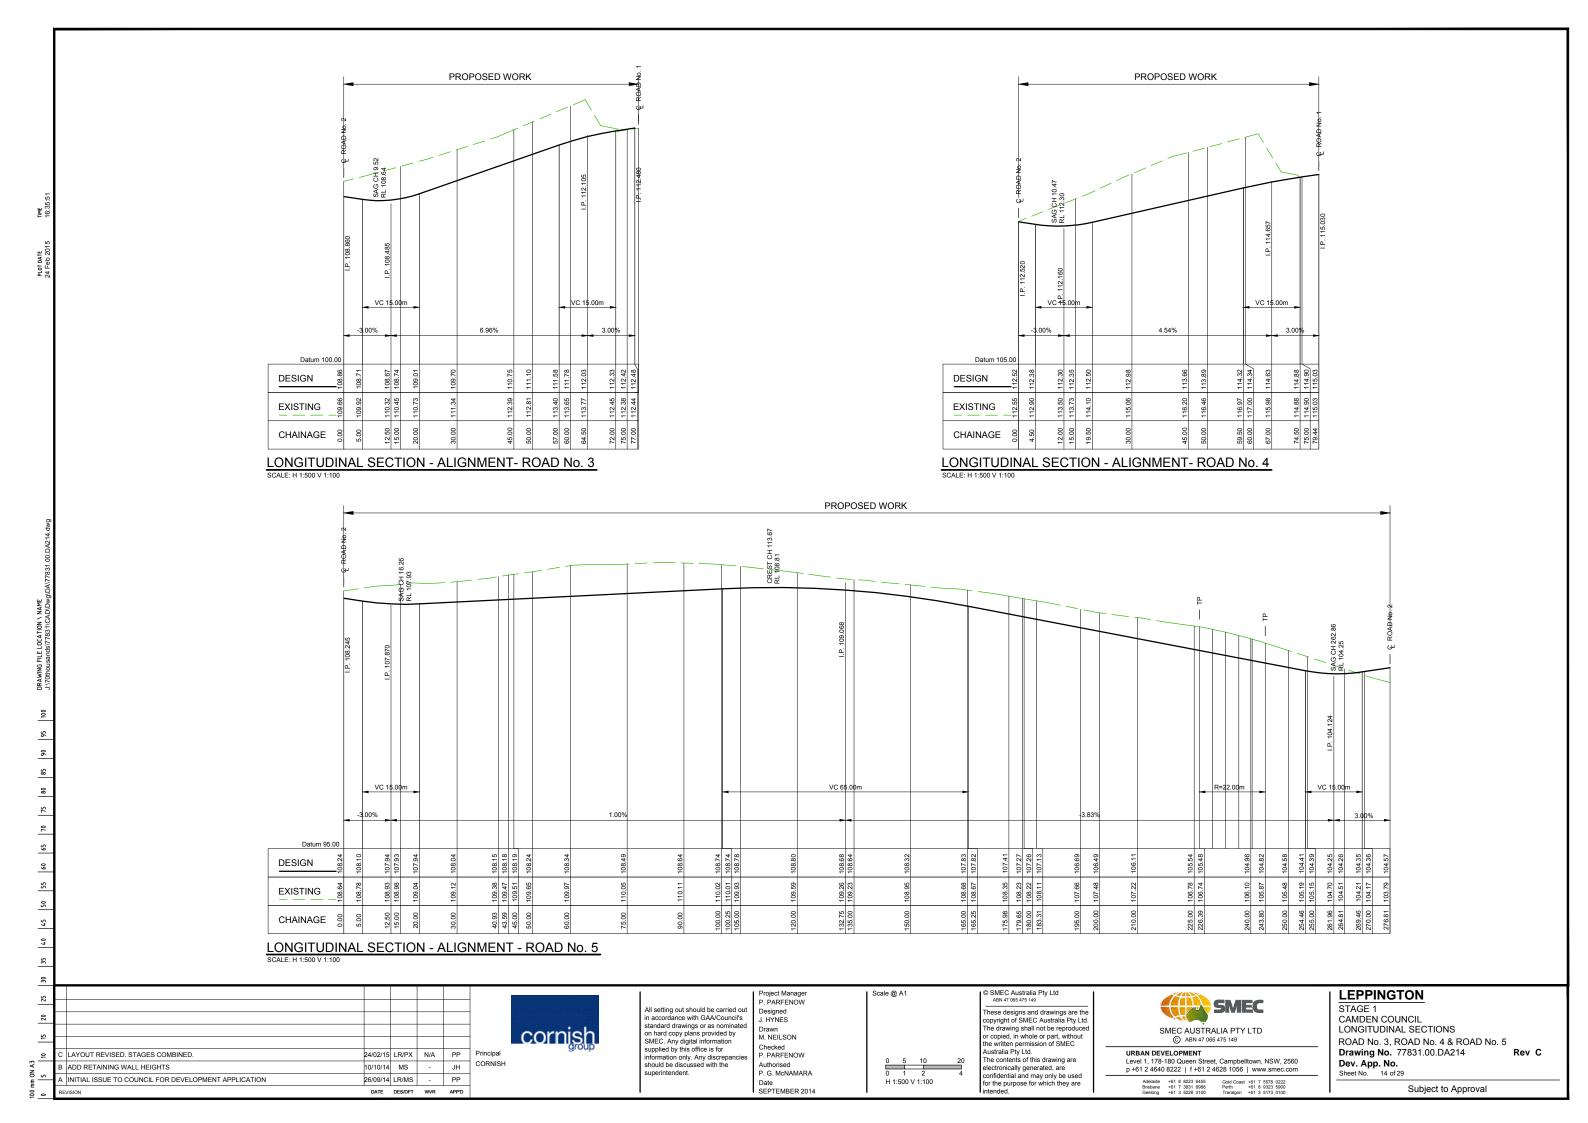

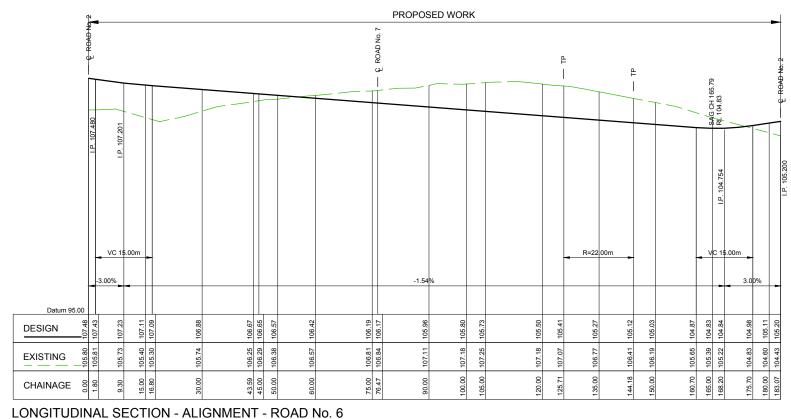

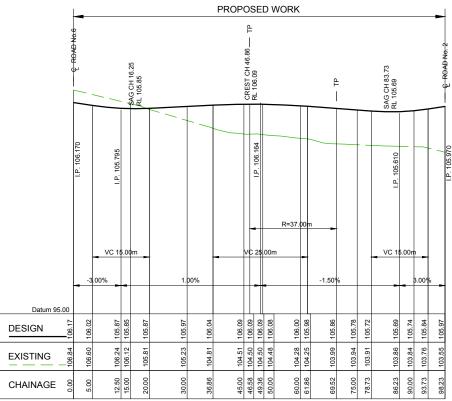LONGITUDINAL SECTION - ALIGNMENT- ROAD No. 7 SCALE: H 1:500 V 1:100

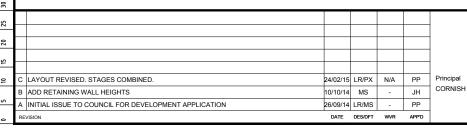

cornish

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Scale @ A1 Checked P. PARFENOW Authorised P. G. McNAMARA

P. PARFENOW

Designed J. HYNES

Drawn M. NEILSON

Date SEPTEMBER 2014

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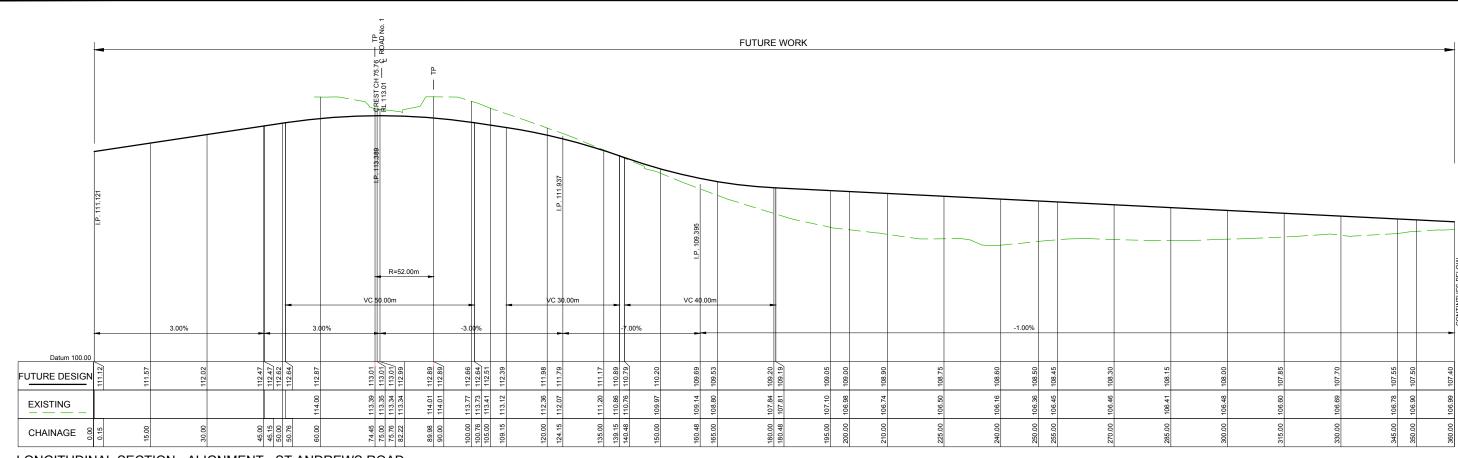
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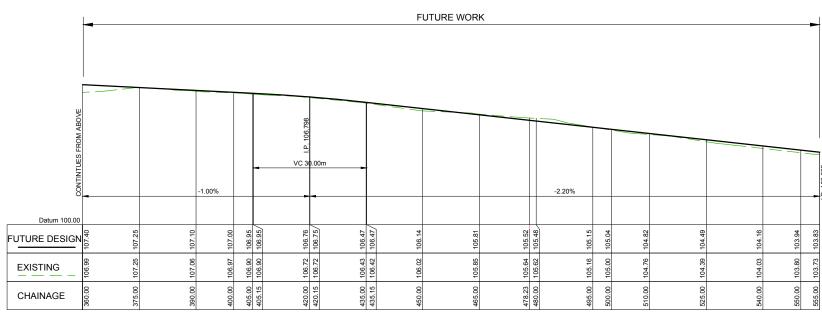
LEPPINGTON

STAGE 1 CAMDEN COUNCIL LONGITUDINAL SECTIONS ROAD No. 6 & ROAD No. 7 Drawing No. 77831.00.DA215 Dev. App. No.


Rev C



LONGITUDINAL SECTION - ALIGNMENT - ST ANDREWS ROAD SCALE: H 1:500 V 1:100



LONGITUDINAL SECTION - ALIGNMENT - ST ANDREWS ROAD SCALE: H 1:500 V 1:100

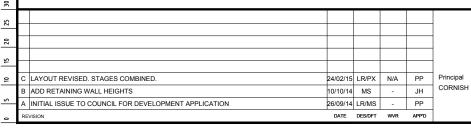

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Date SEPTEMBER 2014

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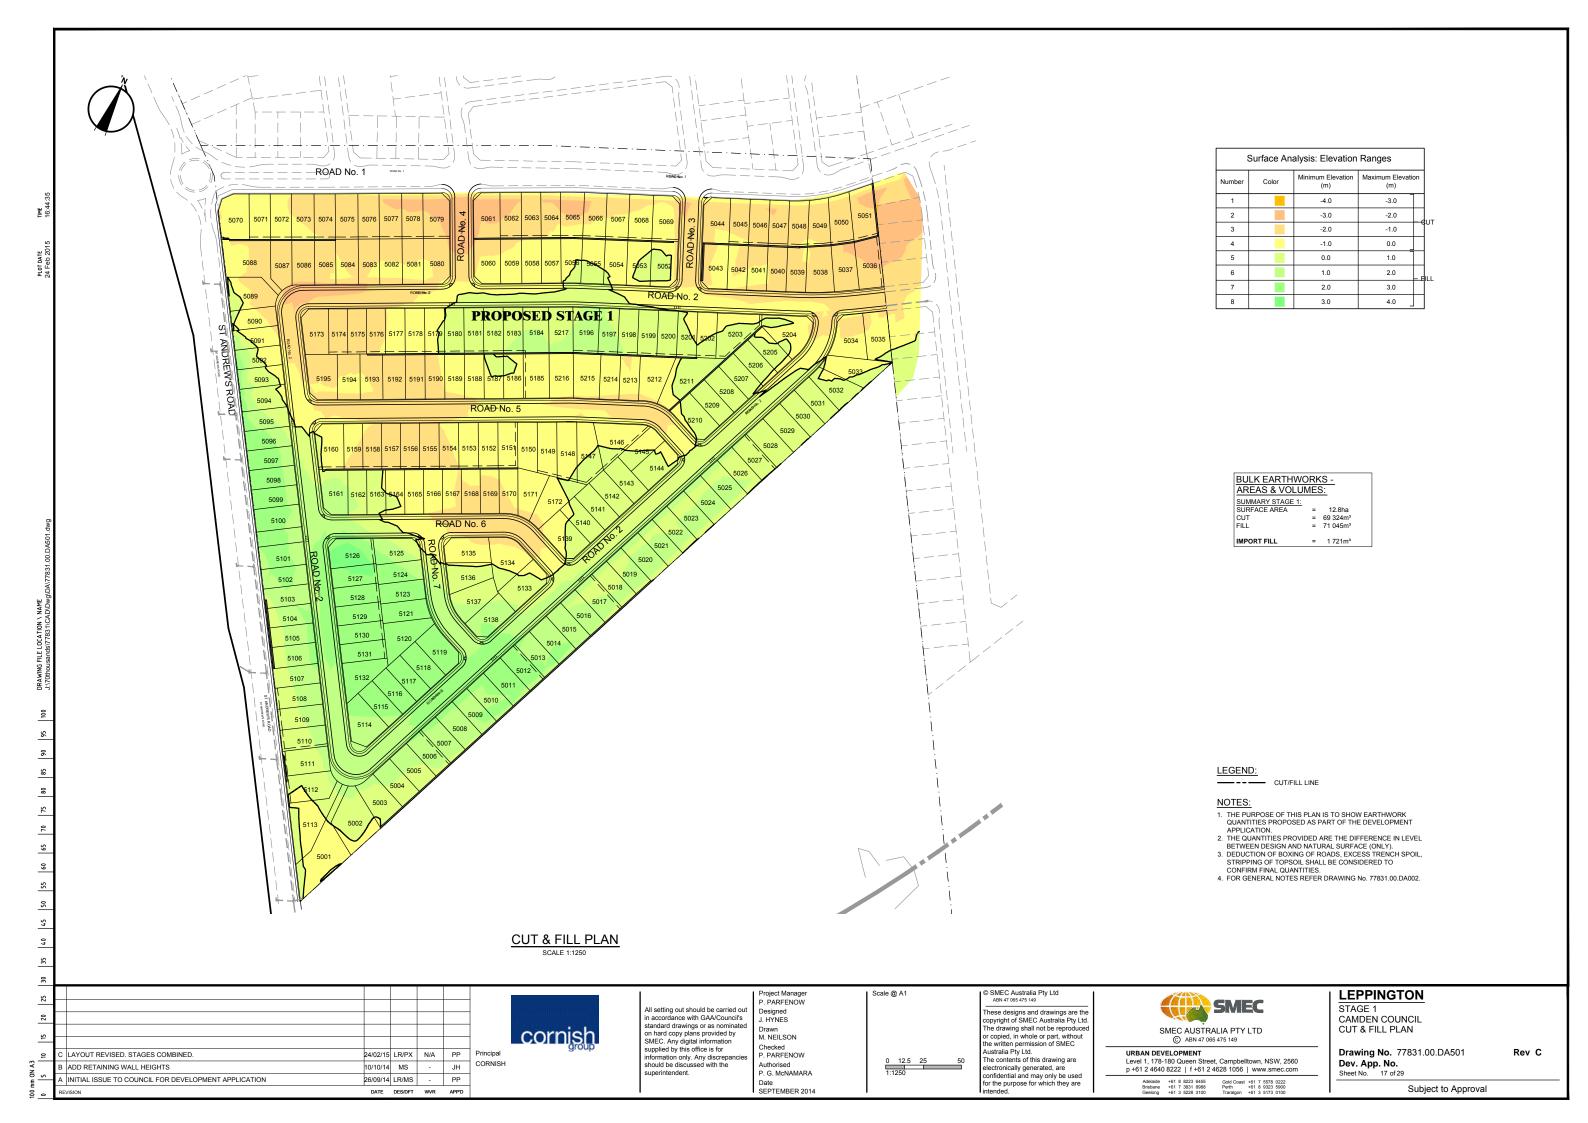
LONGITUDINAL SECTIONS ST ANDREW'S ROAD **Drawing No.** 77831.00.DA216 Dev. App. No.


LEPPINGTON


CAMDEN COUNCIL


STAGE 1


Rev C




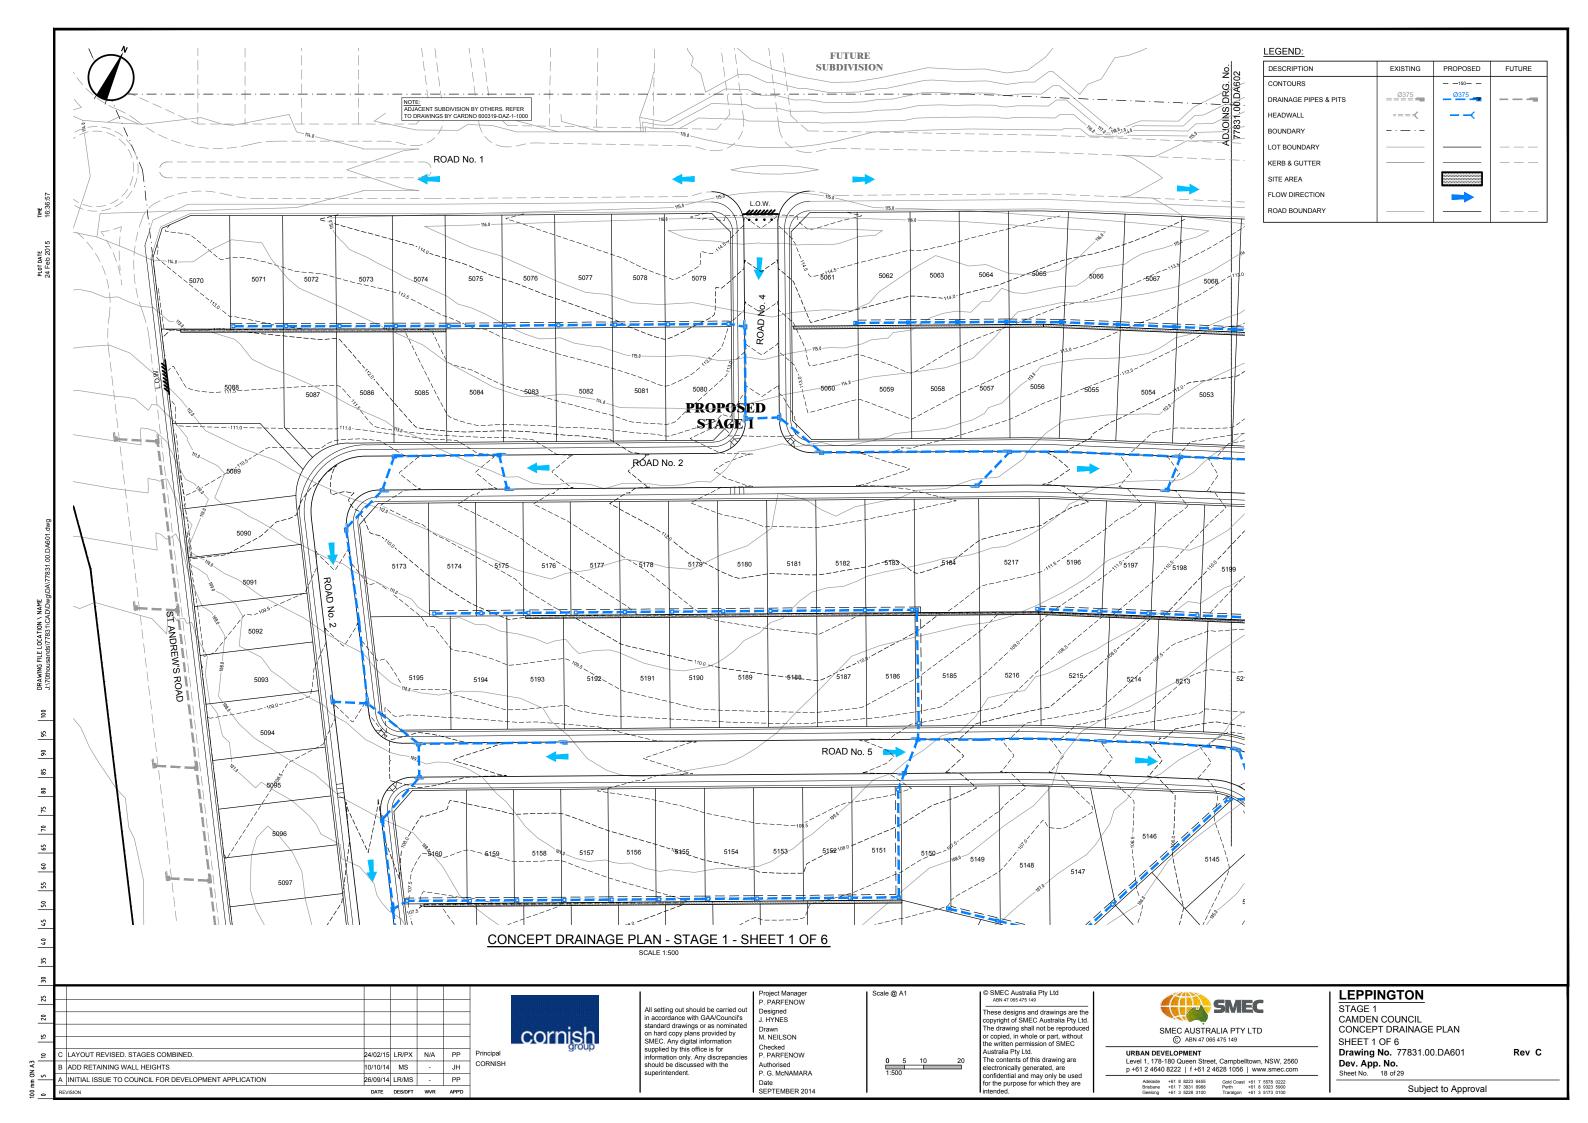


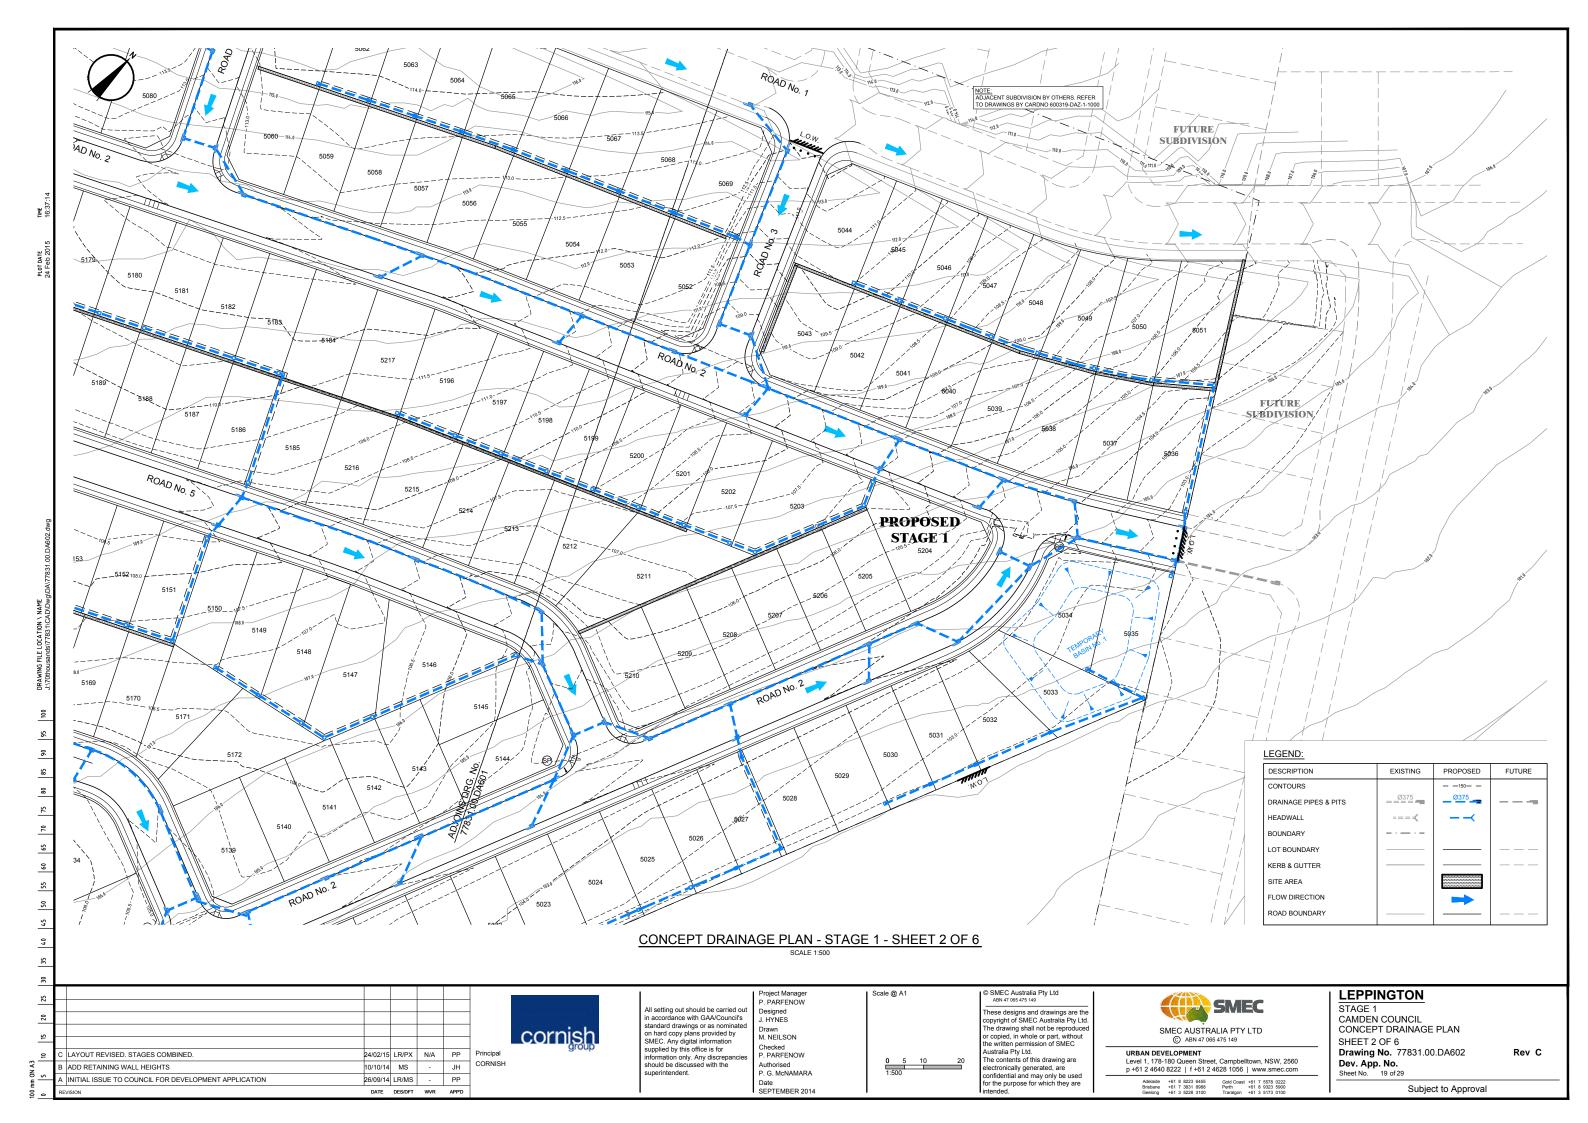


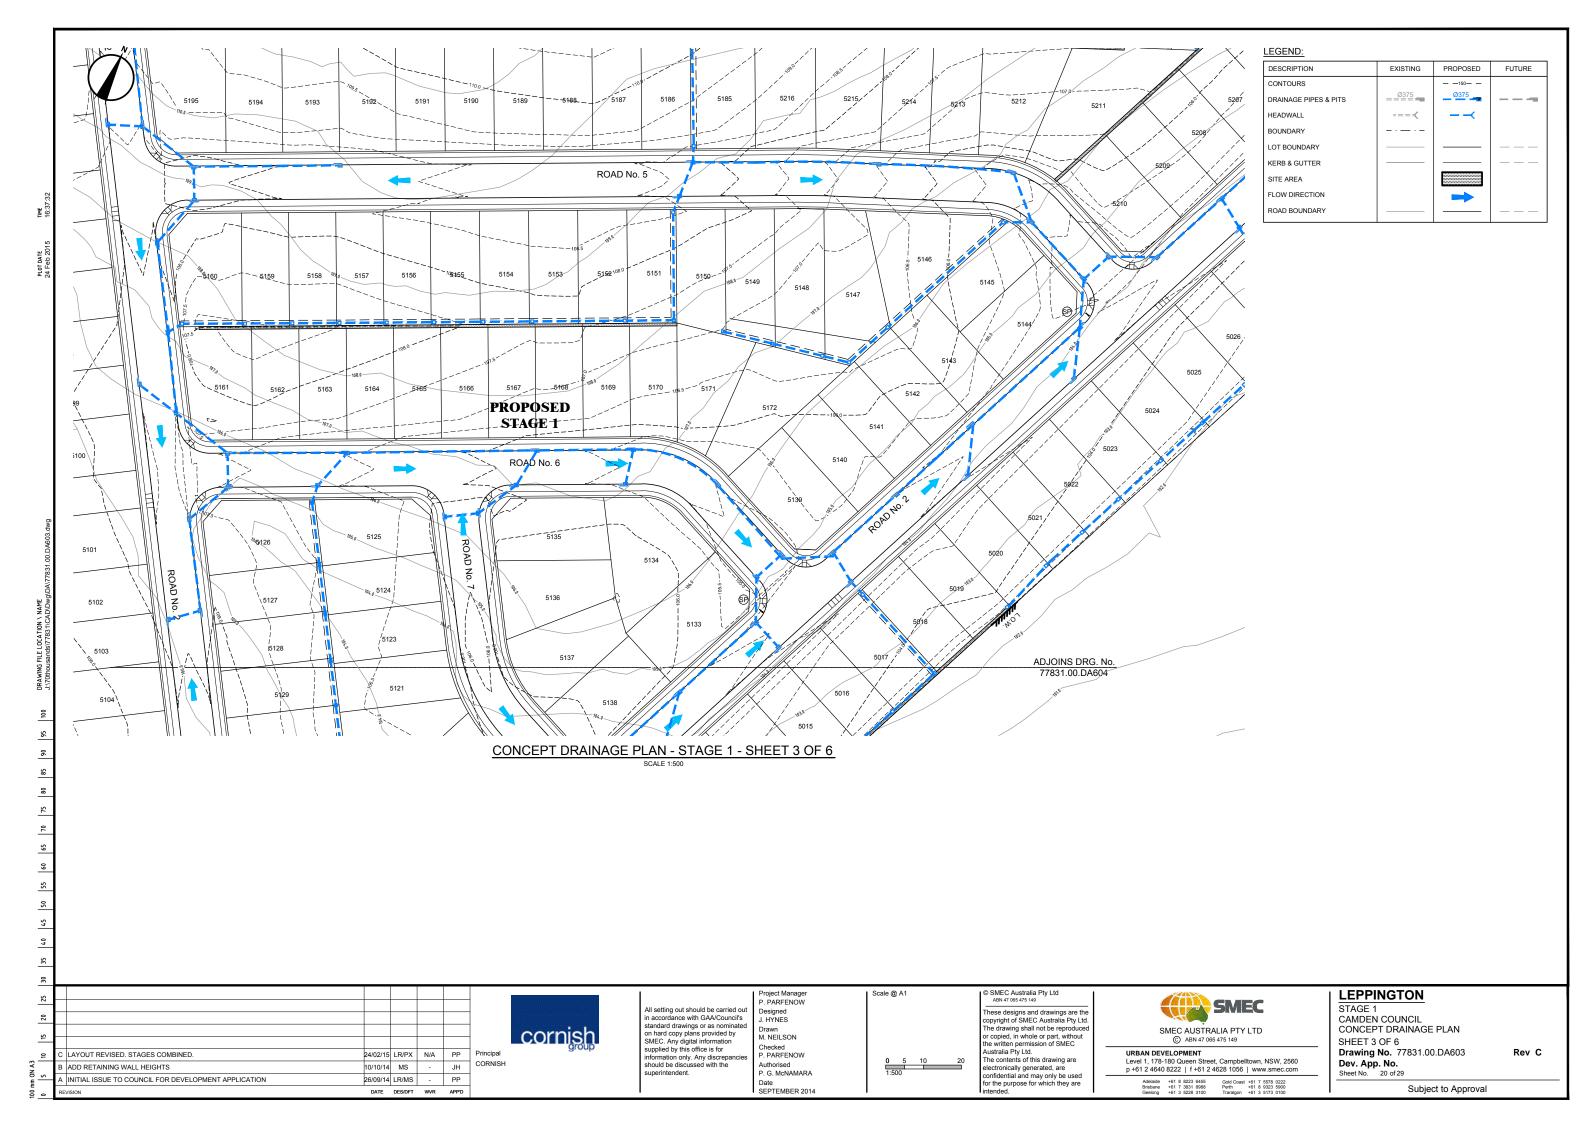


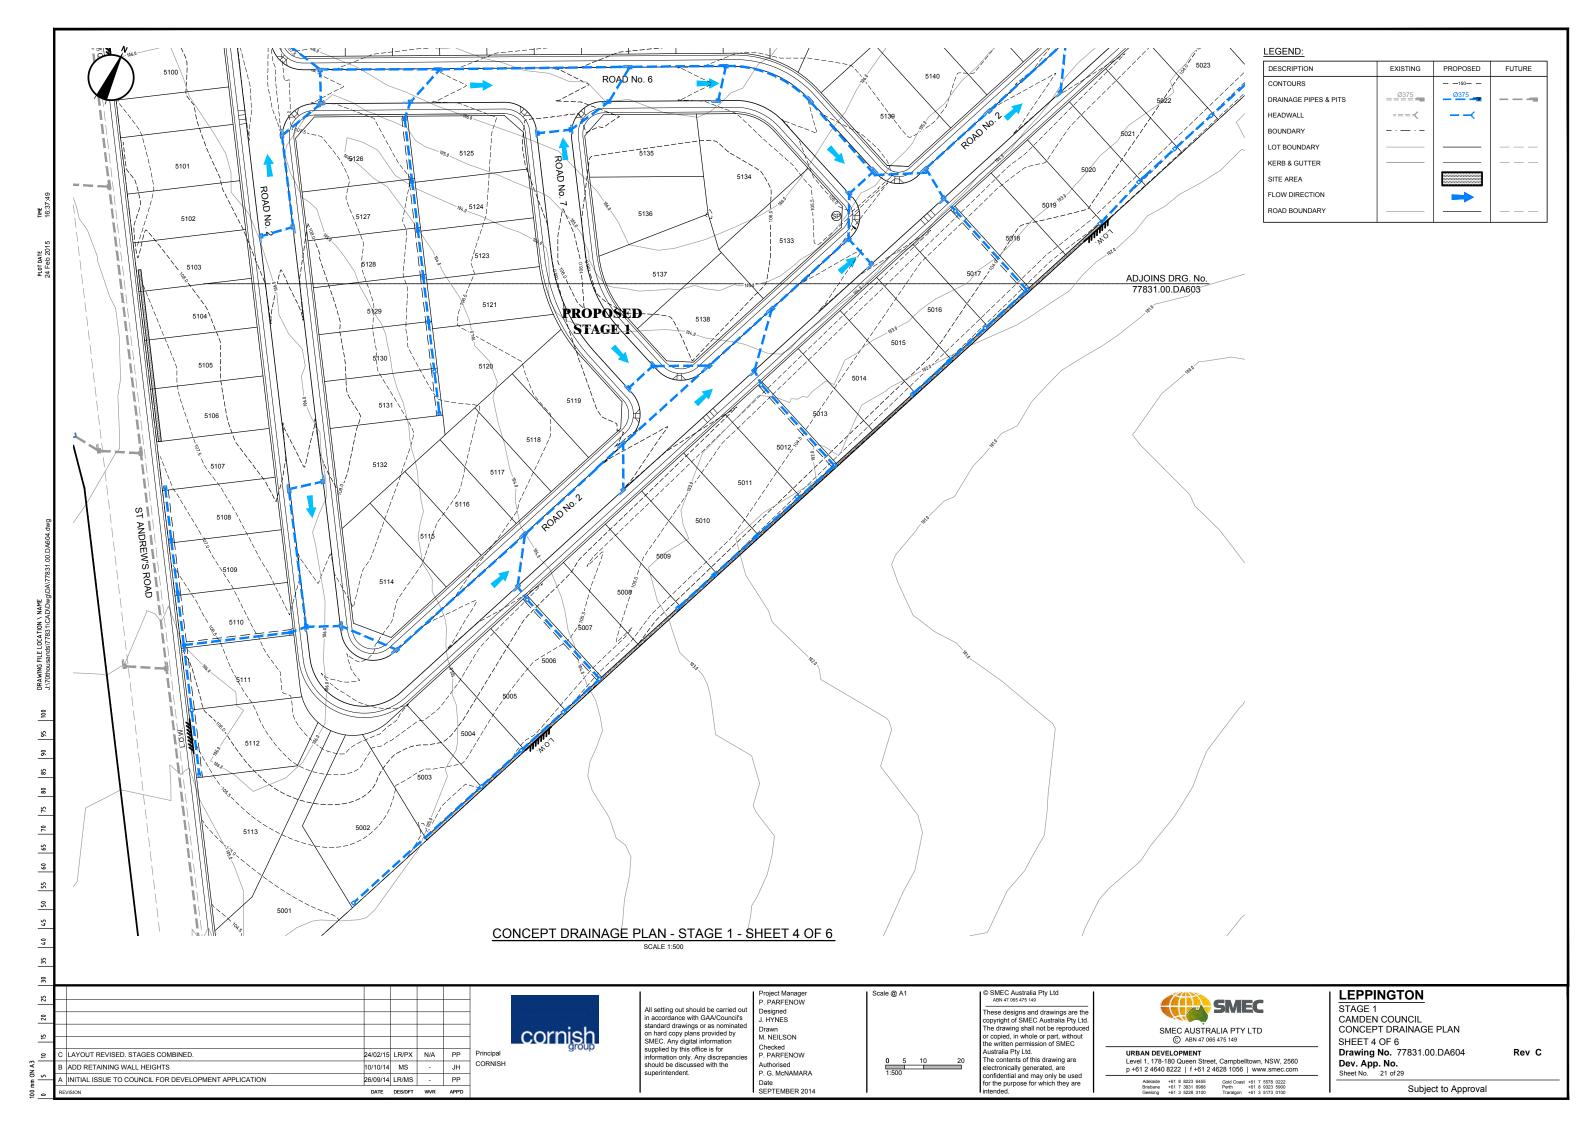


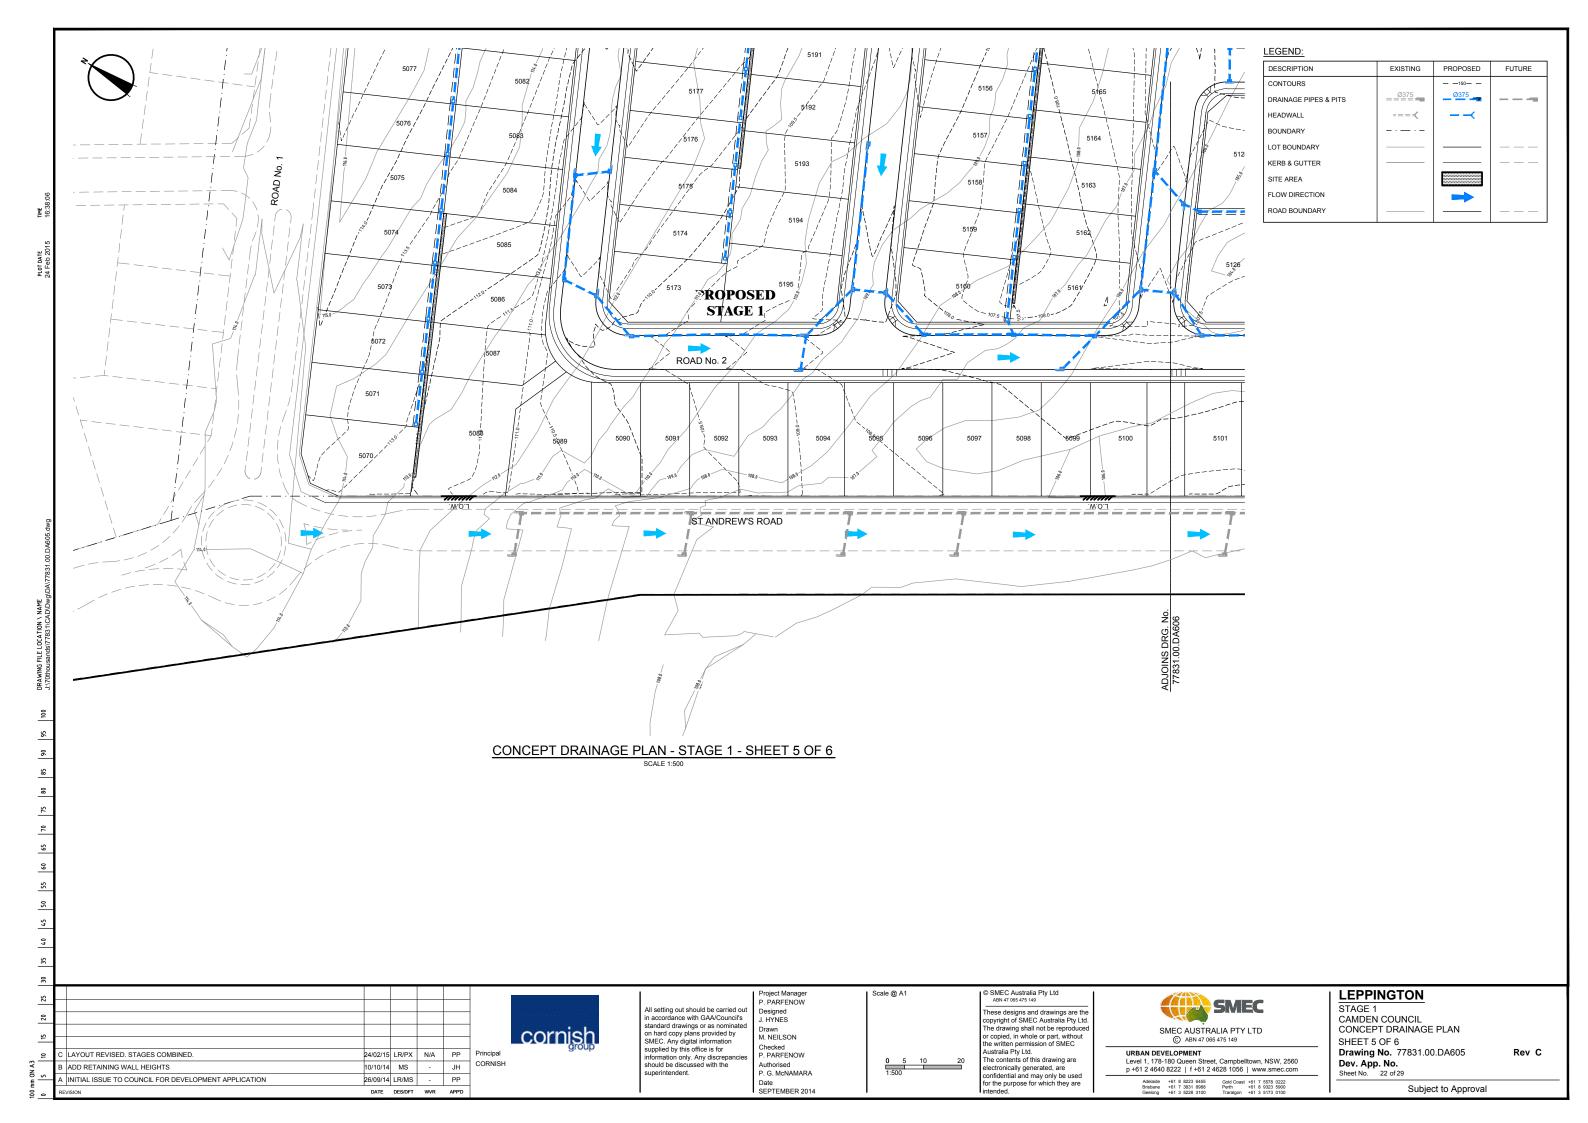

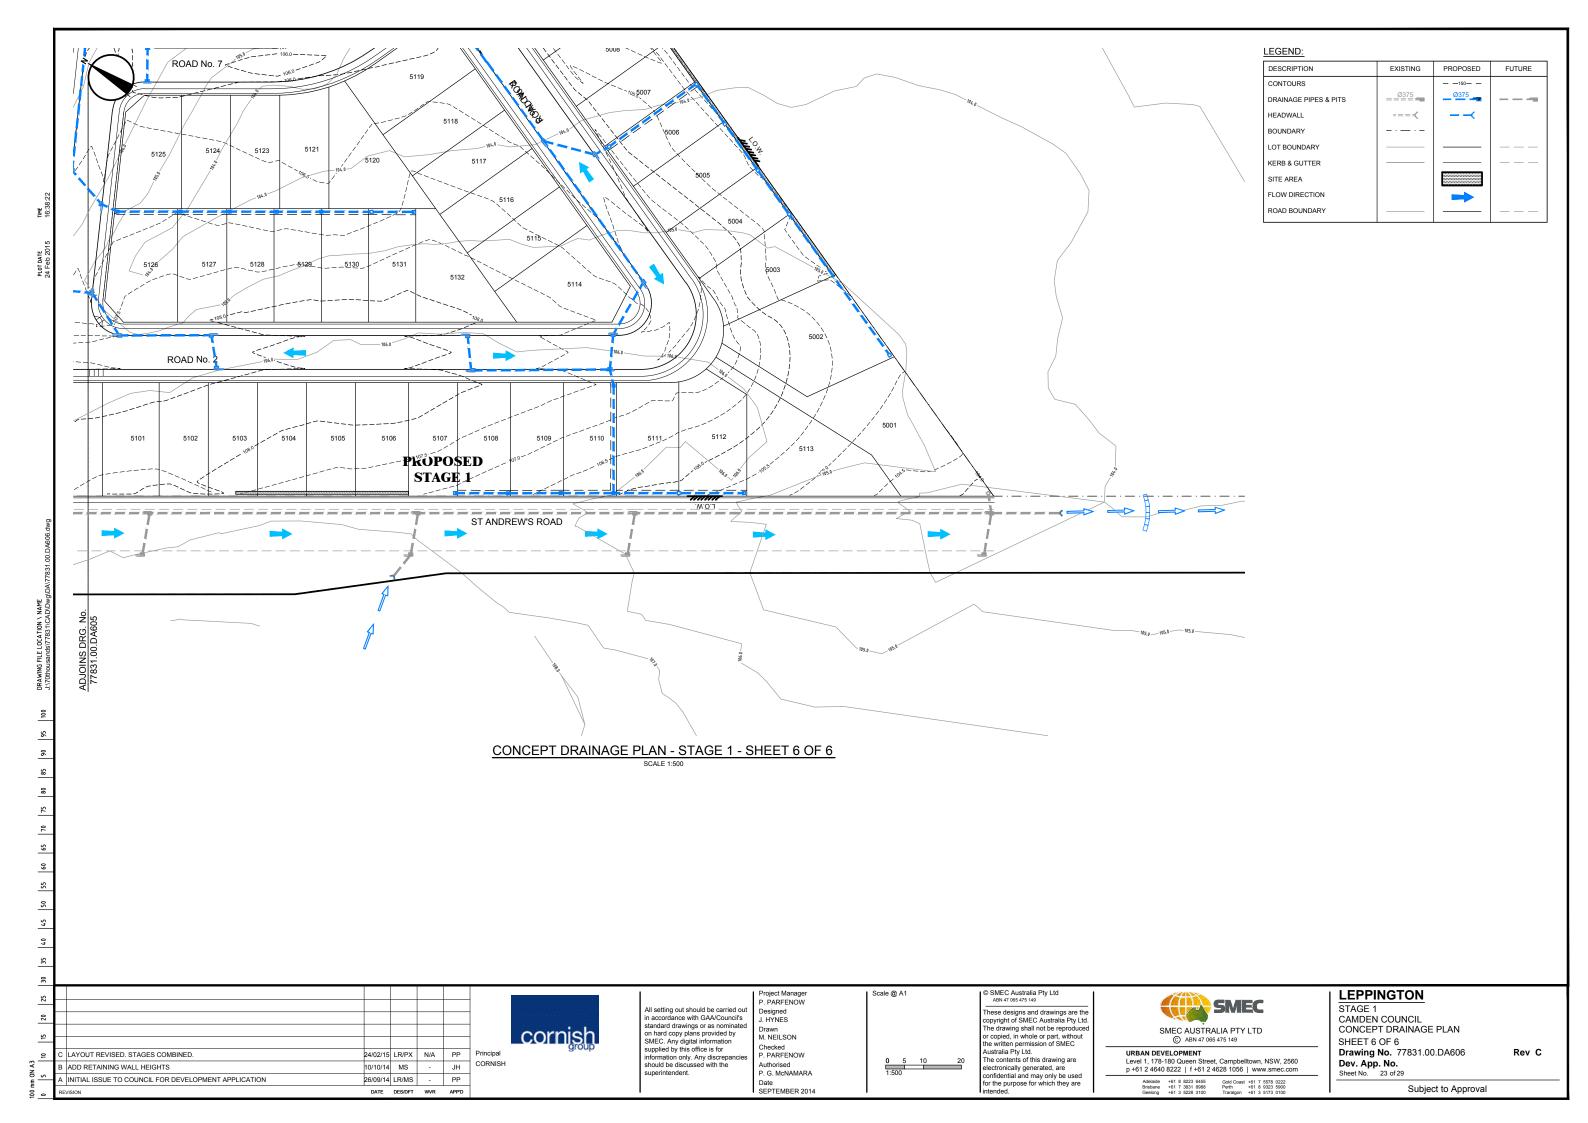

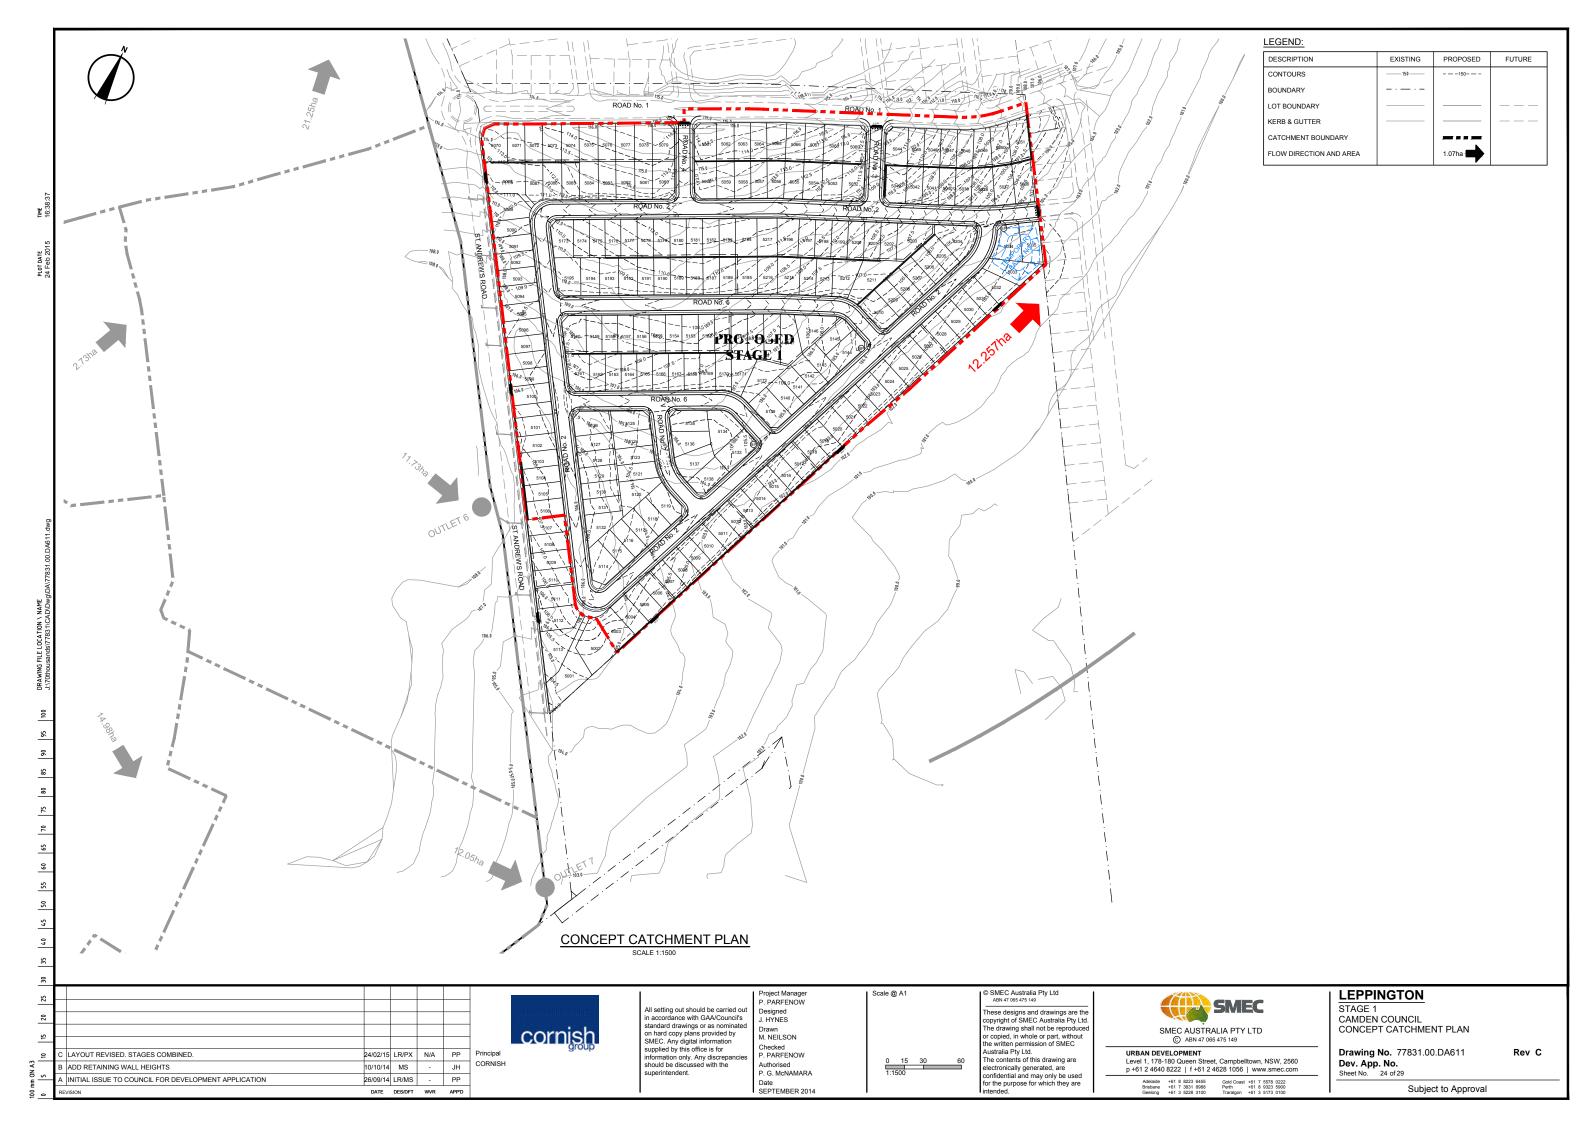

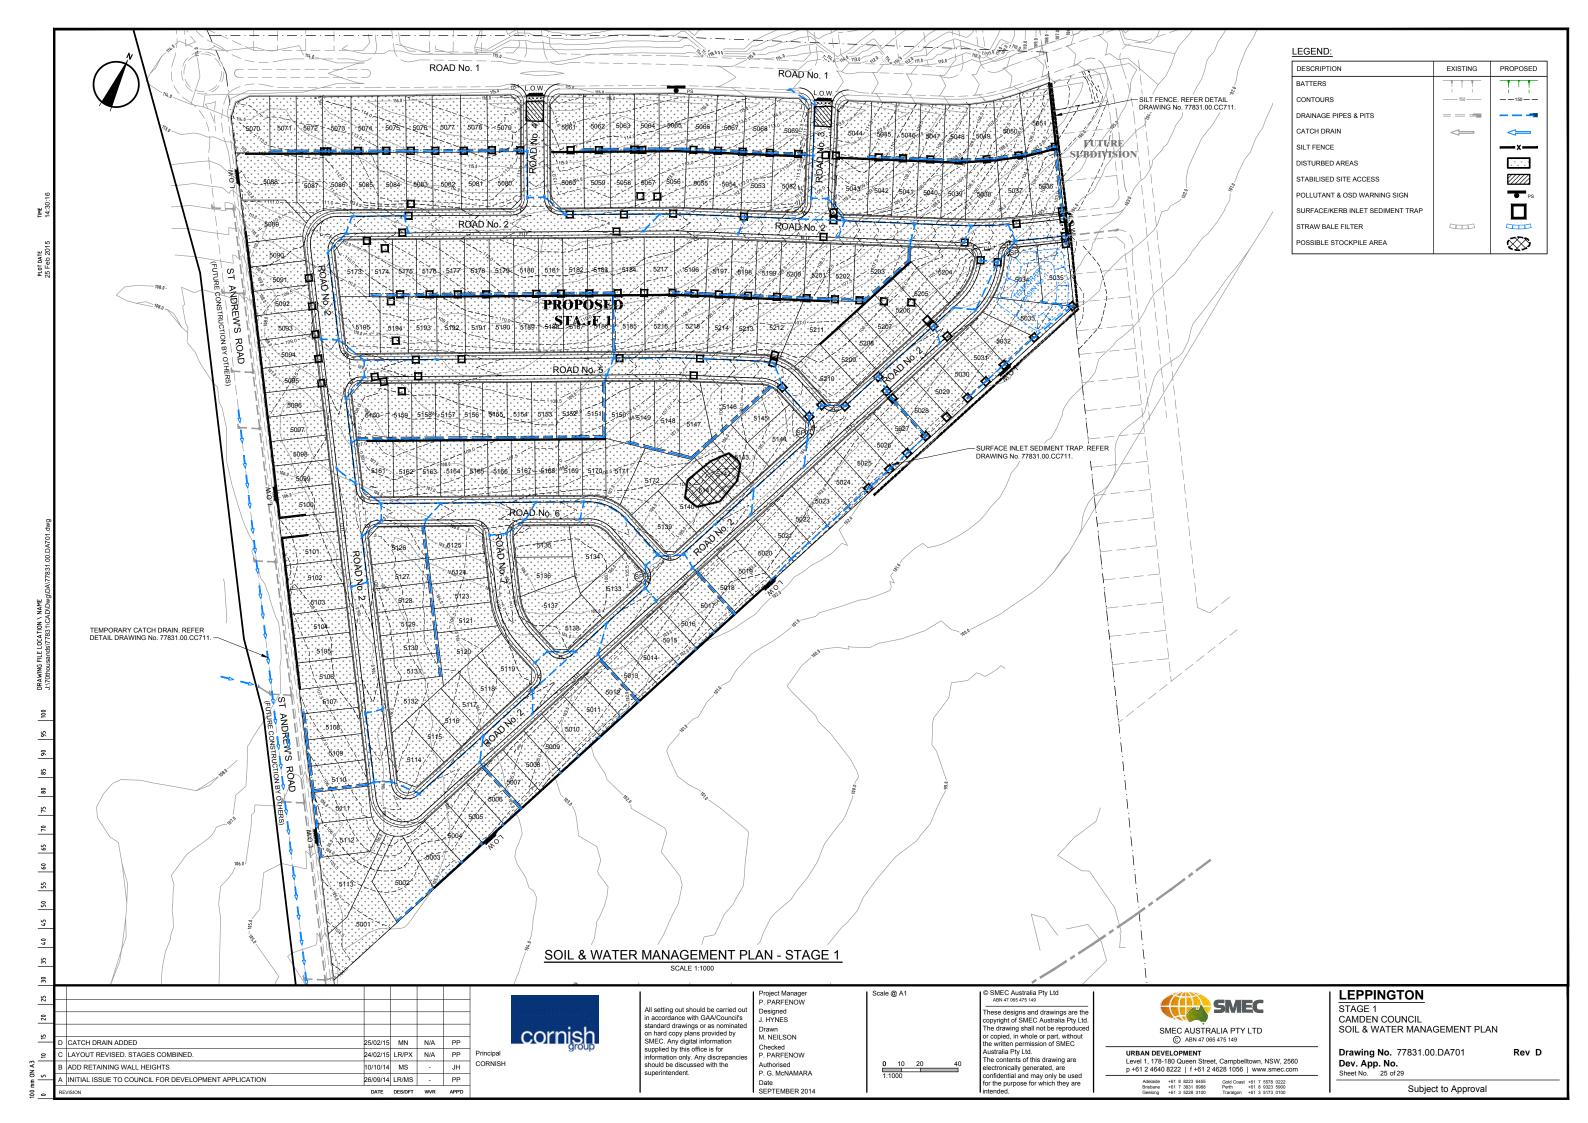

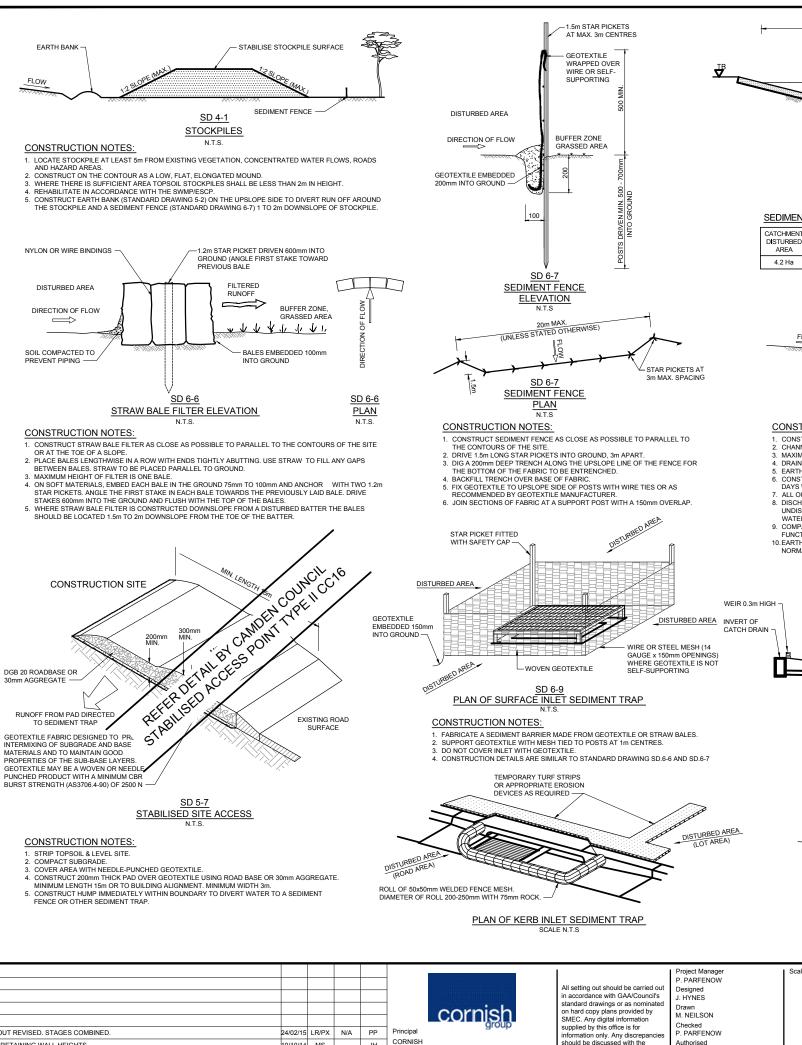


TEMPORARY SEDIMENT / DETENTION BASIN

LENGTH = 70m CLAY IMPERVIOUS LAYER TYPICAL SECTION - SEDIMENT BASIN

SEDIMENT BASIN CALCULATION:

CATCHMENT DISTURBED AREA	SOIL TYPE	Qзмпн FLOW	MINIMUM STORAGE VOLUME	MINIMUM SETTLING DEPTH	PROVIDE DIMENSIONS	PROVIDED STORAGE VOLUME
4 2 Ha	C	∩ 21m ³ /s	1045 2m ³	0.6m	70m v 22m	1060m ³

PHASE 1

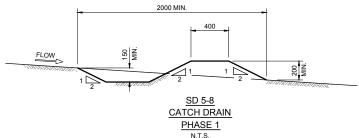

CONSTRUCTION NOTES:

- . CONSTRUCT ALONG GRADIENT AS SPECIFIED.
- CHANNEL GRADIENT 1 5%. MAXIMUM SPACING BETWEEN BANKS SHALL BE 80m

- . MAXIMUM SPACING BEI WEEN BANKS SHALL BE BUIN.

 DRAINS TO BE PARABOLIC OF TRAPEZOIDAL CROSS SECTION NOT V-SHAPED.


 EARTH BANKS TO BE ADEQUATELY COMPACTED IN ORDER TO PREVENT FAILURE.

 CONSTRUCTION IS OF A TEMPORARY NATURE AND SHALL BE COMPLETED AT THE END OF A DAYS WORK IMMEDIATELY PRIOR TO RAIN.


 ALL OUTLETS FROM DISTURBED LANDS ARE TO FEED INTO A SEDIMENT BASIN OR SIMILAR.

 DISCHARGE RUNOFF COLLECTED FROM UNDISTURBED LANDS ONTO EITHER A STABILISED OR AN UNDISTURBED DISPOSAL SITE WITHIN THE SAME SUBCATCHMENT AREA FROM WHICH THE WATER ORIGINATED. WATER ORIGINATED.
- 9. COMPACT WITH A SUITABLE IMPLEMENT IN SITUATIONS WHERE THEY ARE REQUIRED TO
- FUNCTION FOR MORE THAN FIVE DAYS.

 10. EARTH BANKS TO BE FREE OF PROJECTIONS OR OTHER IRREGULARITIES THAT WILL IMPEDE NORMAL FLOW.

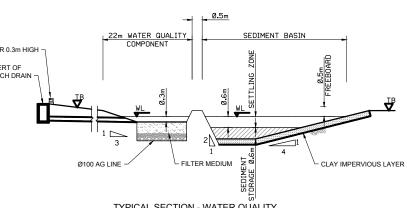

TYPICAL SECTION - WATER QUALITY COMPONENT / SEDIMENT BASIN PHASE 2

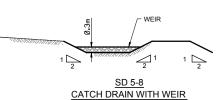

PHASE 2

N.T.S.

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SEDIMENT & EROSION CONTROL

GENERAL NOTES:

- THE CONTRACTOR SHALL IMPLEMENT ALL SOIL EROSION AND SEDIMENT CONTROL
- THE CONTRACTOR SHALL IMPLEMENT ALL SOIL EROSION AND SEDIMENT CONTROL
 MEASURES PRIOR TO DISTURBANCE OF THE RELATED CATCHMENT AREA AND TO THE
 STANDARDS OF THE N.S.W DEPARTMENT OF HOUSING MANAGING URBAN STORMWATER
 "SOILS AND CONSTRUCTION 4TH EDITION MARCH 2004.
 TOPSOIL SHALL BE STRIPPED AND STOCKPILED OUTSIDE HAZARD AREAS AS SHOWN ON
 PLANS. THIS TOPSOIL IS TO BE RESPREAD LATER ON AREAS TO BE REVEGETATED AND
 STABILISED ONLY. (I.E. ALL FOOTPATHS, TOPSOIL SHALL NOT BE RESPREAD ON ANY
 OTHER DEPAIL HIS ESS PATTEOS) SECCIECAL VI SISTULCTED BY THE SIDEDINTENDENT. OTHER AREAS UNLESS BATTERS) SPECIFICALLY INSTRUCTED BY THE SUPERINTENDENT IF STOCKPILES ARE TO REMAIN FOR LONGER THAN 14 DAYS STOCKPILES SHALL BE
- IF STOCKPILES ARE TO REMAIN FOR LONGER THAN 14 DAYS STOCKPILES SHALL BE PROTECTED FROM EROSION BY COVERING THEM WITH A MULCH AND HYDROSEDING AND, IF NECESSARY, BY LOCATING BANKS OR DRAINS UPSLOPE TO DIVERT THE RUNOFF AROUND THEM. IN SOME CIRCUMSTANCES IT MAY BE NECESSARY TO PLACE BANKS OR DRAINS DOWNSTREAM OF A STOCKPILE TO RETARD SEDIMENT LADDE RUNOFF. THE CONTRACTOR SHALL REGULARLY MAINTAIN ALL SEDIMENT LADDE ROSION CONTROL DEVICES AND REMOVE ACCUMULATED SILT FROM SUCH DEVICES BEFORE NO MORE THAN 60% OF THEIR CAPACITY IS LOST. ALL THE SILT REMOVED SHALL BE DISPOSED OF AS DIRECTED BY THE SUPERINTENDENT. NO SILT IS TO BE PLACED OUTSIDE THE LIMIT OF WORKS. THE PERIOD FOR MAINTAINING THESE DEVICES SHALL BE AT LEAST UNTIL ALL DISTURBED AREAS ARE REVEGETATED AND FURTHER AS MAY BE DIRECTED BY THE SUPERINTENDENT OR COUNCIL.

 THE CONTRACTOR SHALL PROVIDE SAND BAGS OR SEDIMENT TRAPS AT 20m CTS ACROSS EACH ROAD GUTTER AS AT COMPLETION OF FOOTPATH FORMATION TO AVOID SEDIMENT LOSS FROM THE ROAD A FOOTPATH AREAS.
- SEDIMENT LOSS FROM THE ROAD & FOOTPATH AREAS.
 VEHICULAR TRAFFIC SHALL BE CONTROLLED DURING CONSTRUCTION CONFINING ACCESS WHERE POSSIBLE TO PROPOSED OR EXISTING ROAD ALIGNMENTS.
- WHEN ANY DEVICES ARE TO BE HANDED OVER TO ROAD & DRAINAGE CONTRACTORS
- WHEN ANY DEVICES ARE 10 BE PANDED VORE TO ROUGH & DRAINAGE CONTRACTORS THEY SHALL BE IN A CLEAN AND STABLE CONDITION.
 THE CONTRACTOR SHALL MAINTAIN ALL REVEGETATED AREAS, INCLUDING WATERING UNTIL FINAL COMPLETION OF WORKS.
 THE CONTRACTOR SHALL MAINTAIN DUST CONTROL UNTIL FINAL COMPLETION OF
- 9. THE CONTRACTOR MUST COMMENCE REHABILITATION WITHIN A REASONABLE TIME OF ANY SITE REGRADING AND BATTER FORMATION.

WASTE CONTROL:

- THE CONTRACTOR TO BE RESPONSIBLE FOR WASTE DISPOSAL ON SITE.
 ALL BUILDING PRODUCTS & CLEARED VEGETATION TO BE REMOVED OFF SITE IN AN
- APPROVED MANNER TO LICENSED LAND FILL SITE.
- 3. EQUIPMENT MAINTENANCE & REFUELLING OF CONSTRUCTION VEHICLES TO BE DONE IN A DESIGNATED AREA USING BUNDING AND BEST PRACTICE MANAGEMENT CONTROLS
- ALL SPILLS TO BE CLEARED UP IMMEDIATELY.

GEOTECHNICAL NOTES:

- THE CONTRACTOR SHALL IMPLEMENT EROSION AND SEDIMENT CONTROL MEASURES AS NECESSARY, AND TO THE SATISFACTION OF COUNCIL PRIOR TO THE COMMENCEMENT OF CONSTRUCTION AND DURING CONSTRUCTION. MAINTENANCE OF THE EROSION AND SEDIMENT CONTROL IS TO BE UNDERTAKEN ON A REGULAR BASIS & AS PER COUNCIL'S DIRECTION.
- TESTS SHALL BE UNDERTAKEN ON ANY PROPOSED FILL MATERIALS TO ENSURE THAT
- 2. TESTS SHALL BE UNDERTAKEN ON ANY PROPOSED FILL MATERIALS TO ENSURE THAT THEY DO NOT HAVE A HIGH DISPERSION POTENTIAL AS DEFINED BY THE EMERSON CRUMB/DISPERSION TESTS (AS1289 C8-1980).

 3. ALL FILL SHALL BE COMPACTED TO NOT LESS THAN 95% OF STANDARD MAXIMUM DRY DENSITY AT -3% TO +3% OF 5TANDARD OPTIMUM MOISTURE CONTENT (MAXIMUM FILL HORIZONS OF 150mm TO 200mm). ALL AREAS WHICH HAVE TEST RESULTS LESS THAN 96% STANDARD SHOULD BE REWORKED AND RETESTED TO ENSURE COMPLIANCE, IN ACCORDANCE WITH A.S.A. 1289 TESTS 12 AND 13.

 4. ALL FILL SHALL BE COMPACTED AT 100% OF STANDARD AND TESTED IN ACCORDANCE WITH CAMDEN COUNCILS ENSINEERING CONSTRUCTION. SPECIFICATION FEBRUARY 2010, ASSOCIATED GUIDELINES AND THE MST CURRENT EDITION AS 1289; SUCH TESTING TO BE UNDERTAKEN BY A NATA REGISTERED LABORATORY.

 5. ALL FILL AREAS TO BE SURVEYED AT STRIPPING AND FINAL STAGES AND LEVELS SHOWN ON PLAN SHADED, (TOGETHER WITH CROSS SECTIONS AT MAXIMUM 20M C/C) AT WORKS-AS-EXECUTED STAGE AND CONTROLLED BY A REGISTERED SURVEYOR. 88B INSTRUMENT REQUIRED FOR ALL LOTS FILLED WITHIN THE BUILDING LINE.

 5. ALL EARTHWORKS SHALL BE CONTROLLED AND CERTIFIED BY A N.A.T.A. REGISTERED LABORATORY. TWO COLLATED COPIES OF ALL TEST CERTIFICATES, ACCOMPANIED BY

- ALL EARTHWORKS SHALL BE CONTROLLED AND CERTIFIED BY A NA. I.A. REGISTERED LABORATORY. TWO COLLATED COPIES OF ALL TEST CERTIFICATES, ACCOMPANIED BY AN OVERALL SITE PLAN, CLEARLY INDICATING THE LOCATION OF EACH TEST AND FILL AREAS ETC. AND THE LABORATORY CERTIFICATE COVERING THE WHOLE OF THE AREA TESTED ARE TO BE FORWARDED TO COUNCIL UPON COMPLETION. TESTING IS TO BE TO LEVEL 1 AS3798 APPENDIX B2(A).
 ALL RESIDENTIAL LOTS SHALL BE INDIVIDUALLY CLASSIFIED IN ACCORDANCE WITH THE LATEST EDITION OF THE GUIDELINES IN THE AUSTRALIAN STANDARD FOR RESIDENTIAL SHAPS AND FOR THE SUPPLIED THE AUSTRALIAN STANDARD FOR RESIDENTIAL SHAPS AND FOR THE SUPPLIED THE AUSTRALIAN STANDARD FOR RESIDENTIAL SHAPS AND FOR THE SUPPLIED THE AUSTRALIAN STANDARD FOR RESIDENTIAL SHAPS AND FOR THE SUPPLIED TO COUNCIL WITH THE AUSTRALIAN STANDARD FOR RESIDENTIAL SHAPS AND FOR THE SUPPLIED TO COLLINCIL
- SLABS AND FOOTINGS AS 2870, PROVIDE TWO COPIES OF REPORT TO COUNCIL.

WEIR NOTES:

- MINIMUM SLOPE ON BASIN FLOOR SHALL BE 1% GRADE FOR WATER QUALITY AND
- MAXIMUM PONDING DEPTH IN WATER QUALITY BASIN SHALL BE 0.5M IN ANY STORM. MAXIMUM PONDING DEPTH IN 1% AEP STORM FOR DETENTION BASIN IS 1.5M
- MAXIMUM.
- MAXIMUM.

 LOW FLOW HAS BEEN DESIGNED TO DRAIN INTO WATER QUALITY BASINS FOR EVENTS OF 3 MONTH TO 1 YEAR FOR WATER QUALITY TREATMENT. THEREFORE FLOW SYSTEM THROUGH THE DETENTION BASIN IS NOT REQUIRED IN THIS CASE. ALL EXPOSED BATTERS AND BASIN AREAS SHALL BE GRASSED.

WATER QUALITY CHECK:

TYPICALLY AS A RULE OF THUMB, 1.5% OF THE CATCHMENT AREA SHALL BE PROVIDED IN A WATER QUALITY DEVICES FOR FILTER MEDIUM. BASED ON THE NATURE OF THE HOUSING PHASE WE ASSUME THAT 100% OF THE CATCHMENT MAY BE DISTURBED AT ANYONE TIME WITH THE REMAINING AREA BEING UNDISTURBED

THEREFORE TO VERIFY THE MINIMUM AREA OF FILTER MEDIUM:

3.05Ha (DISTURBED AREA OF STAGE 40) X 1.5%

LAYOUT REVISED STAGES COMBINED 10/10/14 MS ADD RETAINING WALL HEIGHTS - JH INITIAL ISSUE TO COUNCIL FOR DEVELOPMENT APPLICATION 26/09/14 LR/MS PP DATE DES/DET WVR APP'D

should be discussed with the uperintendent.

P. G. McNAMARA

SEPTEMBER 2014

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LEPPINGTON

STAGE 1 CAMDEN COUNCIL

SOIL & WATER MANAGEMENT DETAILS & NOTES

Drawing No. 77831.00.DA711 Dev. App. No.

Rev C

